




**TILSON SITE #: NY 1008**  
**VZW PROJECT NUMBER: 20202105248**  
**VZW LOCATION CODE: 613602**

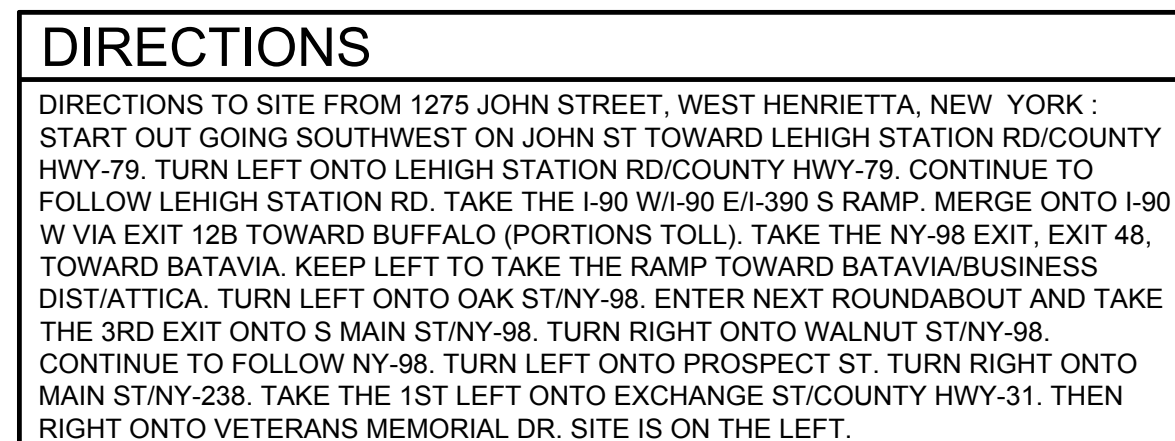

PROJECT DESCRIPTION
THE PROPOSED WORK CONSISTS OF THE CONSTRUCTION AND INSTALLATION OF AN UNMANNED WIRELESS FACILITY WITH ASSOCIATED UTILITIES.

# SHEET INDEX

THIS SET OF PLANS SHALL NOT BE UTILIZED AS CONSTRUCTION DOCUMENTS UNTIL ALL ITEMS OF CONCERN HAVE BEEN ADDRESSED AND EACH OF THE DRAWINGS HAS BEEN REVISED AND ISSUED "FOR CONSTRUCTION".


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NY industrial code rule 753 requires no less than two  
working days notice, but not more than ten days notice.

**DO NOT SCALE DRAWINGS**

THESE DRAWINGS ARE FORMATTED FOR 22"x34" FULL SIZE AND 11"x17" HALF SIZE. OTHER SIZE VARIATIONS ARE NOT PRINTED TO THE SCALE SHOWN. THE CONTRACTOR SHALL VERIFY ALL PLANS, EXISTING DIMENSIONS & CONDITIONS ON THE JOB SITE & SHALL IMMEDIATELY NOTIFY THE ENGINEER IN WRITING OF ANY DISCREPANCIES BEFORE PROCEEDING WITH THE WORK OR BE RESPONSIBLE FOR SAME.



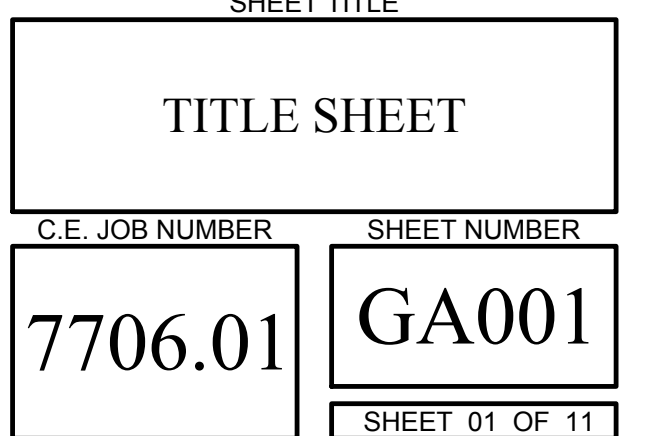

	SECTION / PARCEL BOUNDARY
	MIN. BUILDING SETBACK
	CENTER LINE
	EXIST. RIGHT-OF-WAY LINE
	EXISTING EASEMENT LINE.
	EXIST. CONCRETE CURB
	EXIST. EDGE OF PAVEMENT
	EXIST. EDGE OF GRAVEL
	EXISTING WATER MAIN, VALVE, & HYDRANT.
	EXISTING SANITARY SEWER, & MANHOLE.
	EXISTING DRAINAGE SEWER, FIELD INLET, INLET MANHOLE, MANHOLE, & END SECTION.
	EXISTING OVERHEAD UTILITIES
	EXISTING TELEPHONE
	EXISTING UNDERGROUND UTILITIES
	EXISTING GAS
	EXISTING ELECTRIC
	EXISTING WATER LINE
	EXISTING ELEC & TELE
	EXISTING CABLE TV
	EXISTING FIBER
	EXISTING LIGHT CONTROL
	EXISTING GUARD RAIL
	TREE, HEDGE, EDGE OF WOODS
	EXISTING SWALE
	BARBED WIRE, STOCKADE, CHAIN LINKED FENCE
	EXISTING CONTOUR
	EXISTING SPOT ELEVATION @ X
	CONCRETE PAD/ CONCRETE SIDEWALK
	PROPOSED EASEMENT LINE.
	PROPOSED CONCRETE CURB
	PROPOSED WATER MAIN, VALVE, & HYDRANT.
	PROPOSED SANITARY SEWER, & MANHOLE.
	PROPOSED DRAINAGE SEWER, FIELD INLET, INLET MANHOLE, MANHOLE, & END SECTION.
	PROPOSED OVERHEAD UTILITIES
	PROPOSED TELEPHONE
	PROPOSED UNDERGROUND UTILITIES
	PROPOSED GAS SERVICE
	PROPOSED ELECTRIC SERVICE
	PROPOSED ELEC & TELE
	PROPOSED SILT FENCE
	PROPOSED ORANGE CONSTRUCTION FENCE
	PROPOSED LIMITS OF DISTURBANCE
	PROPOSED COMPOST FILTER SOCK
	PROPOSED GUARD RAILING

1. ALL SITE WORK SHALL BE AS INDICATED ON THE DRAWINGS.
2. RUBBISH, STUMPS, DEBRIS, STICKS, STONES AND OTHER REFUSE SHALL BE REMOVED FROM THE SITE AND DISPOSED OF LEGALLY.
3. THE SITE WORK SHALL BE GRADED TO CAUSE SURFACE WATER TO FLOW AWAY FROM THE PROPOSED PLATFORM.
4. NO FILL OR EMBANKMENT MATERIAL SHALL BE PLACED ON FROZEN GROUND. FROZEN MATERIALS, SNOW OR ICE SHALL NOT BE PLACED IN ANY FILL OR EMBANKMENT.
5. THE SUBGRADE SHALL BE COMPACTED AND BROUGHT TO A SMOOTH UNIFORM GRADE PRIOR TO FINISHED SURFACE APPLICATION.
6. ALL EXISTING ACTIVE SEWER, WATER, GAS, ELECTRIC, AND OTHER UTILITIES WHERE ENCOUNTERED IN THE WORK, SHALL BE PROTECTED AT ALL TIMES, AND WHERE REQUIRED FOR THE PROPER EXECUTION OF THE WORK, SHALL BE RELOCATED AS DIRECTED BY THE ENGINEER. EXTREME CAUTION SHOULD BE USED BY THE CONTRACTOR WHEN EXCAVATING OR PIER DRILLING AROUND OR NEAR UTILITIES.
7. ALL EXISTING INACTIVE SEWER, WATER, GAS, ELECTRIC AND OTHER UTILITIES, WHICH INTERFERE WITH THE EXECUTION OF THE WORK, SHALL BE REMOVED AND/OR CAPPED, PLUGGED OR OTHERWISE DISCONTINUED AT POINTS WHICH WILL NOT INTERFERE WITH THE EXECUTION OF THE WORK, SUBJECT TO THE APPROVAL OF THE ENGINEER.
8. THE AREAS OF THE OWNERS PROPERTY DISTURBED BY THE WORK SHALL BE GRADED TO A UNIFORM SLOPE, FERTILIZED, SEEDED, AND COVERED WITH MULCH.
9. CONTRACTOR SHALL MINIMIZE DISTURBANCE TO EXISTING SITE DURING CONSTRUCTION. EROSION CONTROL MEASURES, IF REQUIRED DURING CONSTRUCTION, SHALL BE IN CONFORMANCE WITH THE STATE GUIDELINES AND ANY LOCAL REGULATIONS.
10. ALL RESTORATION ISSUES SHALL BE COMPLETED WITHIN 72 HOURS OF THE COMPLETION OF THE WORK ACTIVITY OR WITHIN A REASONABLE AMOUNT OF TIME AS DIRECTED BY CONSTRUCTION MANAGER/ENGINEER.
11. CARE SHALL BE TAKEN TO RETAIN NATURAL GROWTH AND PREVENT DAMAGE TO TREES WITHIN AND OUTSIDE THE LIMITS OF CONSTRUCTION AND SPECIFIED WORK AREAS CAUSED BY EQUIPMENT AND MATERIALS. ANY DAMAGE TO THIS NATURAL GROWTH SHALL BE RESTORED AT THE EXPENSE OF THE CONTRACTOR.
12. ALL AREAS DISTURBED BY THE CONTRACTOR WITHOUT AUTHORIZATION SHALL BE RESTORED BY THE CONTRACTOR.
13. IN THE EVENT THE CONTRACTOR DAMAGES AN EXISTING UTILITY SERVICE CAUSING AN INTERRUPTION IN SAID SERVICE, HE SHALL IMMEDIATELY COMMENCE WORK TO RESTORE SERVICE AND MAY NOT CONTINUE HIS WORK OPERATION UNTIL SERVICE IS RESTORED.

1. PROPOSED TOWER AND FOUNDATION TO BE DESIGNED BY A PROFESSIONAL ENGINEER LICENSED IN THE STATE OF NEW YORK.
2. THE VERIFICATION OF STRUCTURAL ADEQUACY AND DESIGN OF THE ATTACHMENTS MUST BE PERFORMED, PRIOR TO THE COMMENCEMENT OF CONSTRUCTION, BY A PROFESSIONAL ENGINEER LICENSED IN THE STATE OF NEW YORK.
3. ALL WORK SHALL CONFORM TO THE CURRENT STANDARD (ANSI/TIA-222-G "STRUCTURAL STANDARD STANDARD FOR ANTENNA SUPPORTING STRUCTURES AND ANTENNAS"), NEW YORK STATE BUILDING CODE, AND ALL OTHER APPLICABLE LOCAL, STATE, AND FEDERAL CODES.

1. TOPOGRAPHY SHOWN FROM A FIELD SURVEY BY COSTICH ENGINEERING, D.P.C. ON 09-22-2020 & 10-15-2020. HORIZONTAL AND VERTICAL DATA OBTAINED THROUGH NGS "OPUS".
2. BOUNDARY SURVEY HAS NOT BEEN PERFORMED BY COSTICH ENGINEERING. BOUNDARY SHOWN HEREON IS APPROXIMATE AND DETERMINED BY LIMITED FIELD LOCATION OF BOUNDARY EVIDENCE, REVIEW OF TITLE COMMITMENT, IF PROVIDED, AND OVERLAY OF COUNTY TAX MAPS AND/OR COUNTY GIS MAPPING.
3. PER THE NYSDEC FRESHWATER WETLANDS MAP, THERE ARE NO STATE WETLANDS IN THE PROJECT AREA.
4. PER THE NATIONAL WETLANDS INVENTORY MAPS THERE ARE NO FEDERAL WETLANDS IN THE PROJECT AREA.
5. PER THE ERSI/FEMA PROJECT IMPACT HAZARD INFORMATION AND AWARENESS SITE MAP THERE IS A NO 100 YR. FLOOD PLAIN EAST OF THE PROJECT AREA.

## TEMPORARY EROSION AND SEDIMENT CONTROL MEASURES

### GENERAL MEASURES:

1. AS MUCH AS IS PRACTICAL, EXISTING VEGETATION SHALL BE PRESERVED. FOLLOWING THE COMPLETION OF CONSTRUCTION ACTIVITIES IN ANY PORTION OF THE SITE, PERMANENT VEGETATION SHALL BE ESTABLISHED ON ALL EXPOSED SOILS.
2. SITE PREPARATION ACTIVITIES SHALL BE PLANNED TO MINIMIZE THE SCOPE AND DURATION OF SOIL DISRUPTION.

### PARTICULAR MEASURES:

1. DRAINAGE DITCH SEDIMENT FILTERS: DITCHES, SHALL RECEIVE CHECK DAMS WITH 2-9 INCH STONE MEETING NYS-DOT LIGHT STONE FILL REQUIREMENTS SO AS TO EFFECTIVELY TRAP SEDIMENT AND MINIMIZE ITS RELEASE OFF-SITE. CHECK DAMS SHALL HAVE A 9" MINIMUM WEIR AND BE CONSTRUCTED WITHIN EACH DITCH BEGINNING AT ITS DOWNSTREAM TERMINUS. CHECK DAMS SHALL BE PLACED WITHIN THE CHANNEL SO THAT THE CREST OF THE DOWNSTREAM DAM IS AT THE ELEVATION OF THE TOE OF THE UPSTREAM DAM.
2. SILT FENCES AND COMPOST FILTER SOCKS SHALL BE CONSTRUCTED AROUND ALL STOCKPILES OF FILL, TOPSOIL AND EXCAVATED OVERBURDEN THAT ARE TO REMAIN FOR PERIODS LESS THAN 30 DAYS. SILT FENCES AND COMPOST FILTER SOCKS SHALL BE ANCHORED AND MAINTAINED IN GOOD CONDITION UNTIL SUCH TIME AS STOCKPILES ARE REMOVED AND STOCKPILING AREAS ARE BROUGHT TO FINAL GRADE AND PERMANENTLY STABILIZED.
3. TOPSOIL AND FILL THAT IS TO REMAIN STOCKPILED ON-SITE FOR PERIODS GREATER THAN 30 DAYS SHALL BE STABILIZED BY SEEDING. PRIOR TO THE SEEDING OPERATION, THE STOCKPILED MATERIAL SHALL BE GRADED AS NEEDED AND FEASIBLE TO PERMIT THE USE OF CONVENTIONAL EQUIPMENT FOR SEEDBED PREPARATION, SEEDING, MULCH APPLICATION AND MULCH ANCHORING.
4. IN NO CASE SHALL ERODIBLE MATERIALS BE STOCKPILED WITH 25 FEET OF ANY DITCH, STREAM, OR OTHER SURFACE WATER BODY.

1. PERMANENT AND TEMPORARY VEGETATIVE COVER: IMMEDIATELY FOLLOWING THE COMPLETION OF CONSTRUCTION ACTIVITY OR WHERE WORK IS DELAYED AND WILL NOT BE DISTURBED FOR 21 DAYS OR MORE IN ANY PORTION OF THE SITE, PERMANENT OR TEMPORARY VEGETATION SHALL BE ESTABLISHED WITHIN 14 DAYS ON ALL EXPOSED SOILS. ALL DISTURBED AREAS SHALL BE SEEDED AND MULCHED AS SOON AS PRACTICAL. FOLLOWING DISTURBANCE TO STABILIZE BARE SOIL AND PROMOTE THE PROMPT RE-ESTABLISHMENT OF VEGETATION.

- A. AN ADEQUATE SEEDBED SHALL BE PREPARED BY SCARIFYING COMPACTED SOIL AND REMOVING SURFACE DEBRIS AND OBSTACLES.
- B. LIME SHALL BE APPLIED SUFFICIENTLY TO ATTAIN A SOIL ACIDITY pH OF 6.0 TO 7.0.
- C. FERTILIZER (5-10-10 MIXTURE OR EQUIVALENT) SHALL BE APPLIED PER SOIL TEST RESULTS OR AT A RATE OF 600 LBS PER ACRE.
- D. DISTURBED AREAS WHICH WILL REMAIN TEMPORARILY FALLOW FOR PERIODS GREATER THAN 14 DAYS SHALL BE SEEDED AT THE FOLLOWING RATE TO PRODUCE TEMPORARY GROUND COVER: 30 LBS RYEGRASS (ANNUAL OR PERENNIAL) PER ACRE. DURING THE WINTER, USE 100 LBS CERTIFIED "AROSTOCK" WINTER RYE (CEREAL RYE) PER ACRE.
- E. PERMANENT SEEDING SHALL BE APPLIED ON 4" MIN. TOPSOIL AT THE FOLLOWING RATE FOR ROUGH OR OCCASIONAL MOWING AREAS:
  - 8 LBS EMPIRE BIRDSFOOT TIREFOIL OR COMMON WHITE CLOVER PER ACRE.
  - 20 LBS TALL FESCUE PER ACRE PLUS
  - 2 LBS REDTOP OR 5 LBS RYEGRASS (PERENNIAL) PER ACRE



FOR MOWED AREAS:

- 65 LBS KENTUCKY BLUEGRASS PER ACRE
- 65 LBS RYEGRASS (PERENNIAL) PER ACRE

F. ALL SEEDING SHALL BE PERFORMED USING THE BROADCAST METHOD OR HYDROSEEDING, UNLESS OTHERWISE APPROVED.

1. THE CONTRACTOR SHALL ON A DAILY BASIS INSPECT AND MAINTAIN THE INTEGRITY AND FUNCTION OF ALL TEMPORARY EROSION AND SEDIMENT CONTROL MEASURES THROUGHOUT THE DURATION OF THE CONSTRUCTION PROCESS.
2. TO ASSURE PROPER FUNCTION, SILTATION BARRIERS SHALL BE MAINTAINED IN GOOD CONDITION AND REINFORCED, EXTENDED, REPAIRED OR REPLACED AS NECESSARY. WASHOUTS SHALL BE IMMEDIATELY REPAIRED, RE-SEEDED AND PROTECTED FROM FURTHER EROSION.
3. SEDIMENT SHALL BE REMOVED FROM BEHIND THE SEDIMENT FENCE WHEN IT BECOMES ABOUT 0.5 FEET DEEP AT THE FENCE AND FROM BEHIND THE COMPOST FILTER SOCKS ONCE IT REACHES 1/2 THE FILTER SOCK HEIGHT. THE SEDIMENT FENCE AND COMPOST FILTER SOCKS SHALL BE REPAIRED AS NECESSARY TO MAINTAIN BARRIER.
4. ALL SEEDED AREAS SHALL BE FERTILIZED, RESEEDED AS NECESSARY, AND MULCHED ACCORDING TO SPECIFICATIONS IN THE VEGETATIVE PLAN IN ORDER TO MAINTAIN A VIGOROUS, DENSE VEGETATIVE COVER.

- TEMPORARY SEDIMENTATION ENTRAPMENT AREAS SHALL BE PROVIDED AT KEY LOCATIONS TO INTERCEPT AND CLARIFY SILT LADEN RUNOFF FROM THE SITE.
2. SILT THAT LEAVES THE SITE IN SPITE OF THE REQUIRED PRECAUTIONS SHALL BE COLLECTED AND REMOVED AS DIRECTED BY APPROPRIATE MUNICIPAL AUTHORITIES.
3. AT THE COMPLETION OF THE PROJECT, ALL TEMPORARY SILTATION DEVICES SHALL BE REMOVED AND THE AFFECTED AREAS REGRADED, OR TREATED IN ACCORDANCE WITH THE APPROVED SITE PLANS.
4. ALL SEDIMENTATION ENTRAPMENT STRUCTURES WILL BE INSPECTED AND MAINTAINED ON A REGULAR BASIS.
5. CONTRACTOR TO INSTALL EROSION CONTROL MEASURES (SILT FENCE AND/ OR COMPOST FILTER SOCKS) AROUND AREAS BEING DISTURBED DURING CONSTRUCTION AND AS NECESSARY.
6. CONTRACTOR TO INSTALL SILT FENCE OR COMPOST FILTER SOCKS DOWNSLOPE OF ALL UTILITY TRENCHES.
7. DISTANCES SHOWN FROM THE WETLANDS IF ANY ON THE CONSTRUCTION PLANS AND SOIL EROSION AND SEDIMENT CONTROL PLANS ESTABLISH THE MINIMUM SEPARATION PERMITTED BETWEEN THE PROPOSED CONSTRUCTION ACTIVITIES AND BOUNDARY OF THE WETLANDS.
- 7.1. AREA OF DISTURBANCE LINES SHALL BE CLEARLY DELINEATED IN THE FIELD BY INSTALLING ORANGE CONSTRUCTION FENCING AROUND THE ENTIRE PROPOSED CONSTRUCTION AREA. EXCEPT AS NECESSARY TO PROVIDE MITIGATION PLANTINGS, NO ENCROACHMENT BEYOND THESE LIMITS BY WORKERS OR MACHINERY SHALL BE PERMITTED.
- 7.2. GRADING AND CLEARING AND OTHER CONSTRUCTION-RELATED ACTIVITIES SHALL TAKE PLACE ONLY WITHIN THE DELINEATED AREA OF DISTURBANCE LINES. THESE AREAS OF DISTURBANCE LINES REPRESENT THE MAXIMUM LIMITS OF CONSTRUCTION ACTIVITIES. EVERY ATTEMPT SHALL BE MADE TO FURTHER REDUCE GRADING AND CLEARING ACTIVITIES WITHIN THE AREA OF DISTURBANCE LINES BY MAINTAINING NATURAL VEGETATION AND TOPOGRAPHY WHEREVER PRACTICABLE.
- 7.3. ALL CONSTRUCTION AND CONSTRUCTION RELATED-ACTIVITIES OCCURRING ON THIS SITE SHALL COMPLY WITH THE STANDARDS AND RECOMMENDATIONS OF THE NEW YORK STATE STANDARDS AND SPECIFICATIONS FOR EROSION AND SEDIMENT CONTROL.
- 7.4. PRIOR TO THE COMMENCEMENT OF ANY SITE WORK, THE APPLICANT SHALL STAKE THE LOCATION OF THE CONSTRUCTION ACTIVITY FOR INSPECTION AND APPROVAL BY THE TOWN ENGINEER (IF REQUIRED).
- 7.5. ALL SOIL EROSION AND SEDIMENTATION CONTROL MEASURES SHOWN ON THIS PLAN SHALL BE IN PLACE PRIOR TO THE START OF ANY SITE WORK. THE TOWN ENGINEER SHALL HAVE INSPECTED THE INSTALLATION OF ALL REQUIRED SOIL EROSION AND SEDIMENTATION CONTROL MEASURES PRIOR TO THE AUTHORIZATION TO PROCEED WITH ANY PHASE OF THE SITE WORK (IF REQUIRED).
- 7.6. THROUGHOUT THE CONSTRUCTION PERIOD, A QUALIFIED PROFESSIONAL RETAINED BY THE APPLICANT SHALL, ON AT LEAST A WEEKLY BASIS, PRIOR TO ANY PREDICTED RAIN EVENT AND AFTER RUNOFF-PRODUCING RAIN EVENT, INSPECT THE SOIL EROSION AND SEDIMENTATION CONTROL MEASURES TO ENSURE THEIR PROPER FUNCTIONING.
- 7.7. ALL DRAINAGE STRUCTURES AND ANY OTHER REQUIRED UTILITY APPURTENANCES SHALL BE INSTALLED AS REQUIRED BY TOWN SPECIFICATIONS AND AS SHOWN ON THESE PLANS.
- 7.8. IF THE APPLICANT, DURING THE COURSE OF CONSTRUCTION, ENCOUNTERS SUCH CONDITIONS AS FLOOD AREAS, UNDERGROUND WATER, SOFT OR SILTY AREAS, IMPROPER DRAINAGE, OR OTHER UNUSUAL CIRCUMSTANCES OR CONDITIONS THAT WERE NOT FORESEEN IN THE ORIGINAL PLANNING, THEY SHALL REPORT SUCH CONDITIONS IMMEDIATELY TO THE TOWN ENGINEER. THE APPLICANT MAY SUBMIT, IF THEY SO DESIRE, THEIR RECOMMENDATIONS AS THE SPECIAL TREATMENT TO BE GIVEN SUCH AREAS TO SECURE ADEQUATE, PERMANENT AND SATISFACTORY CONSTRUCTION. THE TOWN ENGINEER, WITHOUT UNNECESSARY DELAY, SHALL INVESTIGATE THE CONDITION OR CONDITIONS, AND SHALL EITHER APPROVE THE APPLICANT'S RECOMMENDATION TO CORRECT THE CONDITIONS, ORDER A MODIFICATION THEREOF, OR ISSUE THEIR OWN SPECIFICATION FOR THE CORRECTION OF THE CONDITIONS. IN THE EVENT OF THE APPLICANT'S DISAGREEMENT WITH THE DECISION OF THE TOWN ENGINEER, OR IN THE EVENT OF A SIGNIFICANT CHANGE RESULTING TO THE SITE PLAN OR ANY CHANGE THAT INVOLVES WETLAND REGULATED AREAS, THE MATTER SHALL BE DECIDED BY THE PLANNING BOARD. ANY SUCH CONDITIONS OBSERVED BY THE PLANNING BOARD OR ITS AGENTS SHALL BE SIMILARLY TREATED.

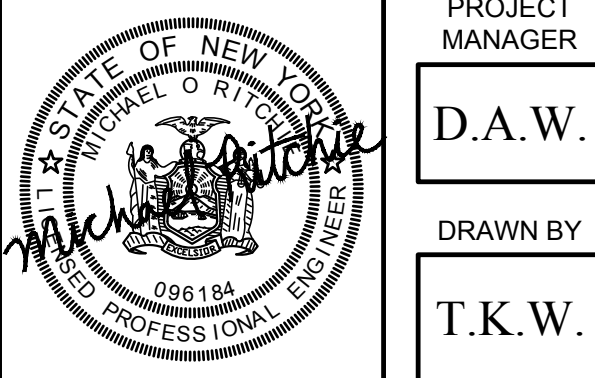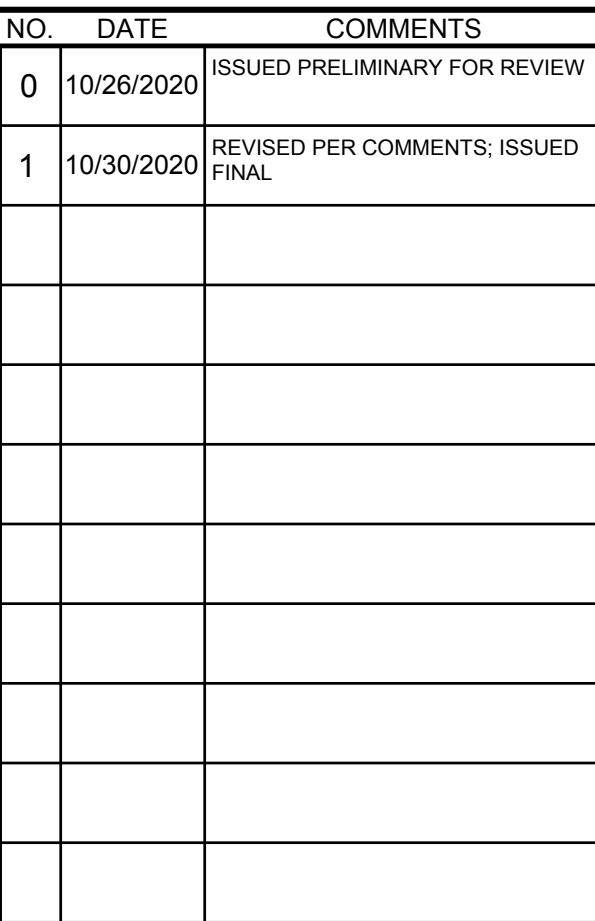

IT IS A VIOLATION OF LAW FOR ANY PERSON, UNLESS ACTING UNDER THE DIRECTION OF A LICENSED PROFESSIONAL ENGINEER, LAND SURVEYOR, ARCHITECT OR LANDSCAPE ARCHITECT, TO ALTER ANY ITEM ON THIS DOCUMENT IN ANY WAY. ANY LICENSEE WHO ALTERS THIS DOCUMENT IS REQUIRED BY LAW TO AFFIX HIS/ HER SEAL AND THE NOTATION "ALTERED BY", FOLLOWED BY HIS/ HER SIGNATURE AND SPECIFIC DESCRIPTION OF THE ALTERATION, TO THE DOCUMENT.

## SITE INFORMATION

VILLAGE OF ATTICA  
COUNTY OF WYOMING  
STATE OF NEW YORK

SHEET TITLE

C.E. JOB NUMBER	SHEET NUMBER
7706.01	GA002
	SHEET 02 OF 11







DESCRIPTION OF ACCESS EASEMENT

ALL THAT TRACT OR PARCEL OF LAND SITUATE IN THE VILLAGE OF ATTICA, COUNTY OF WYOMING, STATE OF NEW YORK, ALL AS SHOWN ON A MAP ENTITLED "ATTICA SITE #. NY 1008 SURVEY PLAN", PREPARED BY COSTICH ENGINEERING, D.P.C., HAVING DRAWING NO. 7706.01 VA100, DATED 10/26/2000, AND BEING MORE PARTICULARLY BOUNDED AND DESCRIBED AS FOLLOWS:

COMMENCING AT AN EXISTING 1/2" IRON PIPE ON THE ASSUMED EASTERLY BOUNDS OF EXCHANGE STREET, SAID EXISTING 1/2" IRON PIPE BEING THE SOUTHWESTERLY CORNER OF LANDS NOW OR FORMERLY OWNED BY THE VILLAGE OF ATTICA-ATTICA MEMORIAL PARK (T.A. #6.14-3-47.1); THENCE

- A. NORTHERLY, ALONG SAID ASSUMED EASTERLY BOUNDS OF EXCHANGE STREET, A DISTANCE OF 26.7 FEET TO THE POINT AND PLACE OF BEGINNING; THENCE
1. NORTHERLY, ALONG THE AFORESAID LINE, A DISTANCE OF 32.1 FEET TO A POINT; THENCE
2. N89°15'42"E, A DISTANCE OF APPROXIMATELY 490 FEET TO A POINT; THENCE
3. NORTHEASTERLY, ALONG A CURVE TO THE LEFT HAVING A DELTA ANGLE OF 72°39'40", A RADIUS OF 215.00 FEET, AND AN ARC DISTANCE OF 272.66 FEET, SAID CURVE ALSO HAVING A CHORD OF N52°55'53"E 254.75 FEET TO A POINT; THENCE
4. N16°36'03"E, A DISTANCE OF 112.72 FEET TO A POINT; THENCE
5. NORTHERLY, ALONG A CURVE TO THE LEFT HAVING A DELTA ANGLE OF 52°35'24", A RADIUS OF 435.00 FEET, AND AN ARC DISTANCE OF 399.27 FEET, SAID CURVE ALSO HAVING A CHORD OF N09°41'39"W 385.40 FEET TO A POINT; THENCE
6. N35°59'22"W, A DISTANCE OF 15.28 FEET TO A POINT; THENCE
7. NORTHWESTERLY, ALONG A NON TANGENT CURVE; SAID CURVE TO THE LEFT HAVING A DELTA ANGLE OF 53°29'30", A RADIUS OF 215.00 FEET, AND AN ARC LENGTH OF 200.73 FEET, SAID CURVE ALSO HAVING A CHORD OF N64°14'48"W 193.51 FEET TO A POINT; THENCE
8. S89°00'27"W, A DISTANCE OF APPROXIMATELY 730 FEET TO A POINT; THENCE
9. NORTHERLY, ALONG SAID ASSUMED EASTERLY BOUNDS OF EXCHANGE STREET, A DISTANCE OF 30 FEET TO A POINT; THENCE
- 10.N89°00'27"E, A DISTANCE OF APPROXIMATELY 540 FEET TO A POINT; THENCE
- 11.N00°00'00"E, A DISTANCE OF 33.49 FEET TO A POINT; THENCE
- 12.NORTHEASTERLY, ALONG A CURVE TO THE RIGHT HAVING A DELTA ANGLE OF 56°33'18", A RADIUS OF 101.00 FEET, AND AN ARC DISTANCE OF 99.69 FEET, SAID CURVE ALSO HAVING A CHORD OF N28°16'39"E 95.70 FEET TO A POINT; THENCE
- 13.N56°33'18"E, A DISTANCE OF 21.00 FEET TO A POINT; THENCE
- 14.NORTHEASTERLY, ALONG A CURVE TO THE RIGHT HAVING A DELTA ANGLE OF 30°20'18", A RADIUS OF 101.00 FEET, AND AN ARC DISTANCE OF 53.48 FEET, SAID CURVE ALSO HAVING A CHORD OF N71°43'27"E 52.86 FEET TO A POINT; THENCE
- 15.N86°53'36"E, A DISTANCE OF 62.81 FEET TO A POINT; THENCE
- 16.NORTHEASTERLY, ALONG A CURVE TO THE LEFT HAVING A DELTA ANGLE OF 63°14'01", A RADIUS OF 71.00 FEET, AND AN ARC DISTANCE OF 78.36 FEET, SAID CURVE ALSO HAVING A CHORD OF N55°16'35"E 74.44 FEET TO A POINT; THENCE
- 17.N23°39'35"E, A DISTANCE OF 50.43 FEET TO A POINT; THENCE
- 18.N77°25'29"W, A DISTANCE OF 32.08 FEET TO A POINT; THENCE
- 19.N12°34'31"E, A DISTANCE OF 105.00 FEET TO A POINT; THENCE
- 20.S77°25'29"E, A DISTANCE OF 30.00 FEET TO THE NORTHWESTERLY CORNER OF THE PROPOSED TILSON LEASE PARCEL; THENCE
- 21.S12°34'31"W, ALONG THE WESTERLY BOUNDS OF SAID PROPOSED TILSON LEASE PARCEL, DISTANCE OF 75.00 FEET TO THE SOUTHWESTERLY CORNER OF SAID PROPOSED TILSON LEASE PARCEL; THENCE
- 22.S77°25'29"E, ALONG THE SOUTHERLY BOUNDS OF SAID PROPOSED TILSON LEASE PARCEL, DISTANCE OF 75.00 FEET TO THE SOUTHEASTERLY CORNER OF SAID PROPOSED TILSON LEASE PARCEL; THENCE
- 23.S12°34'31"W, A DISTANCE OF 30.00 FEET TO A POINT; THENCE
- 24.N77°25'29"W, A DISTANCE OF 42.35 FEET TO A POINT; THENCE
- 25.S23°39'35"W, A DISTANCE OF 56.31 FEET TO A POINT; THENCE
- 26.SOUTHWESTERLY, ALONG A CURVE TO THE RIGHT HAVING A DELTA ANGLE OF 63°14'01", A RADIUS OF 101.00 FEET, AND AN ARC DISTANCE OF 111.47 FEET, SAID CURVE ALSO HAVING A CHORD OF S55°16'35"W 105.90 FEET TO A POINT; THENCE
- 27.S86°53'36"W, A DISTANCE OF 62.81 FEET TO A POINT; THENCE
- 28.SOUTHWESTERLY, ALONG A CURVE TO THE LEFT HAVING A DELTA ANGLE OF 30°20'18", A RADIUS OF 71.00 FEET, AND AN ARC DISTANCE OF 37.59 FEET, SAID CURVE ALSO HAVING A CHORD OF S71°43'27"W 37.16 FEET TO A POINT; THENCE
- 29.S56°33'18"W, A DISTANCE OF 21.00 FEET TO A POINT; THENCE
- 30.SOUTHWESTERLY, ALONG A CURVE TO THE LEFT HAVING A DELTA ANGLE OF 56°33'18", A RADIUS OF 71.00 FEET, AND AN ARC DISTANCE OF 70.08 FEET, SAID CURVE ALSO HAVING A CHORD OF S28°16'39"W 67.27 FEET TO A POINT; THENCE
- 31.S00°00'00"E, A DISTANCE OF 32.97 FEET TO A POINT; THENCE
- 32.N89°00'27"E, A DISTANCE OF 159.39 FEET TO A POINT; THENCE
- 33.SOUTHEASTERLY, ALONG A CURVE TO THE RIGHT HAVING A DELTA ANGLE OF 53°35'14", A RADIUS OF 245.00 FEET, AND AN ARC DISTANCE OF 229.14 FEET, SAID CURVE ALSO HAVING A CHORD OF S64°11'56"E 220.88 FEET TO A POINT; THENCE
- 34.S35°59'22"E, A DISTANCE OF 15.66 FEET TO A POINT; THENCE
- 35.SOUTHERLY, ALONG A CURVE TO THE RIGHT HAVING A DELTA ANGLE OF 52°35'24", A RADIUS OF 465.00 FEET, AND AN ARC DISTANCE OF 426.81 FEET, SAID CURVE ALSO HAVING A CHORD OF S09°41'39"E 411.98 FEET TO A POINT; THENCE
- 36.S16°36'03"W, A DISTANCE OF 112.72 FEET TO A POINT; THENCE
- 37.SOUTHWESTERLY, ALONG A CURVE TO THE RIGHT HAVING A DELTA ANGLE OF 72°39'40", A RADIUS OF 245.00 FEET, AND AN ARC DISTANCE OF 310.70 FEET, SAID CURVE ALSO HAVING A CHORD OF S52°55'53"W 290.30 FEET TO A POINT; THENCE
- 38.S89°15'42"W, A DISTANCE OF APPROXIMATELY 480 FEET TO THE POINT AND PLACE OF BEGINNING.

DESCRIPTION OF LEASE PARCEL

ALL THAT TRACT OR PARCEL OF LAND SITUATE IN THE VILLAGE OF ATTICA, COUNTY OF WYOMING, STATE OF NEW YORK, ALL AS SHOWN ON A MAP ENTITLED "ATTICA SITE #. NY 1008 SURVEY PLAN", PREPARED BY COSTICH ENGINEERING, D.P.C., HAVING DRAWING NO. 7706.01 VA100, DATED 10/26/2000, AND BEING MORE PARTICULARLY BOUNDED AND DESCRIBED AS FOLLOWS:

COMMENCING AT AN EXISTING 1/2" IRON PIPE ON THE ASSUMED EASTERLY BOUNDS OF EXCHANGE STREET, SAID EXISTING 1/2" IRON PIPE BEING THE SOUTHWESTERLY CORNER OF LANDS NOW OR FORMERLY OWNED BY THE VILLAGE OF ATTICA-ATTICA MEMORIAL PARK (T.A. #6.14-3-47.1); THENCE

- A. N25°39'00"E, A DISTANCE OF 1,212.84 FEET TO THE POINT AND PLACE OF BEGINNING; THENCE
1. N12°34'31"E, A DISTANCE OF 75.00 FEET TO A POINT; THENCE
2. S77°25'29"E, A DISTANCE OF 75.00 FEET TO A POINT; THENCE
3. S12°34'31"W, A DISTANCE OF 75.00 FEET TO A POINT; THENCE
4. N77°25'29"W, A DISTANCE OF 75.00 FEET TO THE POINT AND PLACE OF BEGINNING, CONTAINING 0.129 ACRES OF LAND, MORE OR LESS.

DESCRIPTION OF UTILITY EASEMENT

ALL THAT TRACT OR PARCEL OF LAND SITUATE IN THE VILLAGE OF ATTICA, COUNTY OF WYOMING, STATE OF NEW YORK, ALL AS SHOWN ON A MAP ENTITLED "ATTICA SITE #. NY 1008 SURVEY PLAN", PREPARED BY COSTICH ENGINEERING, D.P.C., HAVING DRAWING NO. 7706.01 VA100, DATED 10/26/2000, AND BEING MORE PARTICULARLY BOUNDED AND DESCRIBED AS FOLLOWS:

COMMENCING AT AN EXISTING 1/2" IRON PIPE ON THE ASSUMED EASTERLY BOUNDS OF EXCHANGE STREET, SAID EXISTING 1/2" IRON PIPE BEING THE SOUTHWESTERLY CORNER OF LANDS NOW OR FORMERLY OWNED BY THE VILLAGE OF ATTICA-ATTICA MEMORIAL PARK (T.A. #6.14-3-47.1); THENCE

- A. N25°39'00"E, A DISTANCE OF 1,212.84 FEET TO THE SOUTHWESTERLY CORNER OF THE PROPOSED TILSON 75X75' LEASE PARCEL; THENCE
- B. N12°34'31"E, ALONG THE WESTERLY BOUNDS OF SAID PROPOSED TILSON 75X75' LEASE PARCEL, A DISTANCE OF 75.00 FEET TO THE POINT AND PLACE OF BEGINNING, SAID POINT OF BEGINNING BEING THE NORTHWESTERLY CORNER OF SAID PROPOSED TILSON 75X75' LEASE PARCEL; THENCE
1. S12°34'31"W, ALONG SAID WESTERLY BOUNDS OF THE PROPOSED TILSON 75X75' LEASE PARCEL, A DISTANCE OF 8.22 FEET TO A POINT; THENCE
2. N33°23'01"W, A DISTANCE OF APPROXIMATELY 107 FEET TO A POINT ON THE COMMON LINE BETWEEN LANDS NOW OR FORMERLY OWNED BY THE VILLAGE OF ATTICA (T.A. #6.14-3-46.1) TO THE SOUTH AND LANDS NOW OR FORMERLY OWNED BY PENNSYLVANIA LINES LLC (T.A. #6.14-2-65) TO THE NORTH; THENCE
3. EASTERLY, ALONG SAID COMMON LINE BETWEEN LANDS NOW OR FORMERLY OWNED BY THE VILLAGE OF ATTICA (T.A. #6.14-3-46.1) TO THE SOUTH AND LANDS NOW OR FORMERLY OWNED BY PENNSYLVANIA LINES LLC (T.A. #6.14-2-65) TO THE NORTH, A DISTANCE OF 11.9 FEET TO A POINT; THENCE
4. S33°23'01"E, A DISTANCE OF APPROXIMATELY 99 FEET TO A POINT ON THE NORTHERLY BOUNDS OF SAID PROPOSED TILSON 75X75' LEASE PARCEL; THENCE
5. N77°25'29"W, ALONG SAID NORTHERLY BOUNDS OF THE PROPOSED TILSON 75X75' LEASE PARCEL, A DISTANCE OF 5.88 FEET TO THE POINT AND PLACE OF BEGINNING.






**COSTICH  
ENGINEERING**

- CIVIL ENGINEERING
- LAND SURVEYING
- LANDSCAPE ARCHITECTURE

217 LAKE AVENUE  
ROCHESTER, NY 14608  
(585) 458-3020

NO.	DATE	COMMENTS
0	10/26/2020	ISSUED PRELIMINARY FOR REVIEW
1	10/30/2020	REVISED PER COMMENTS; ISSUED FINAL



PROJECT  
MANAGER

D.A.W.

DRAWN BY

T.K.W.

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ATTICA  
SITE #: NY 1008

VILLAGE OF ATTICA  
COUNTY OF WYOMING  
STATE OF NEW YORK

SHEET TITLE

SURVEY NOTES

C.E. JOB NUMBER

7706.01

SHEET NUMBER


VA110

SHEET 04 OF 11








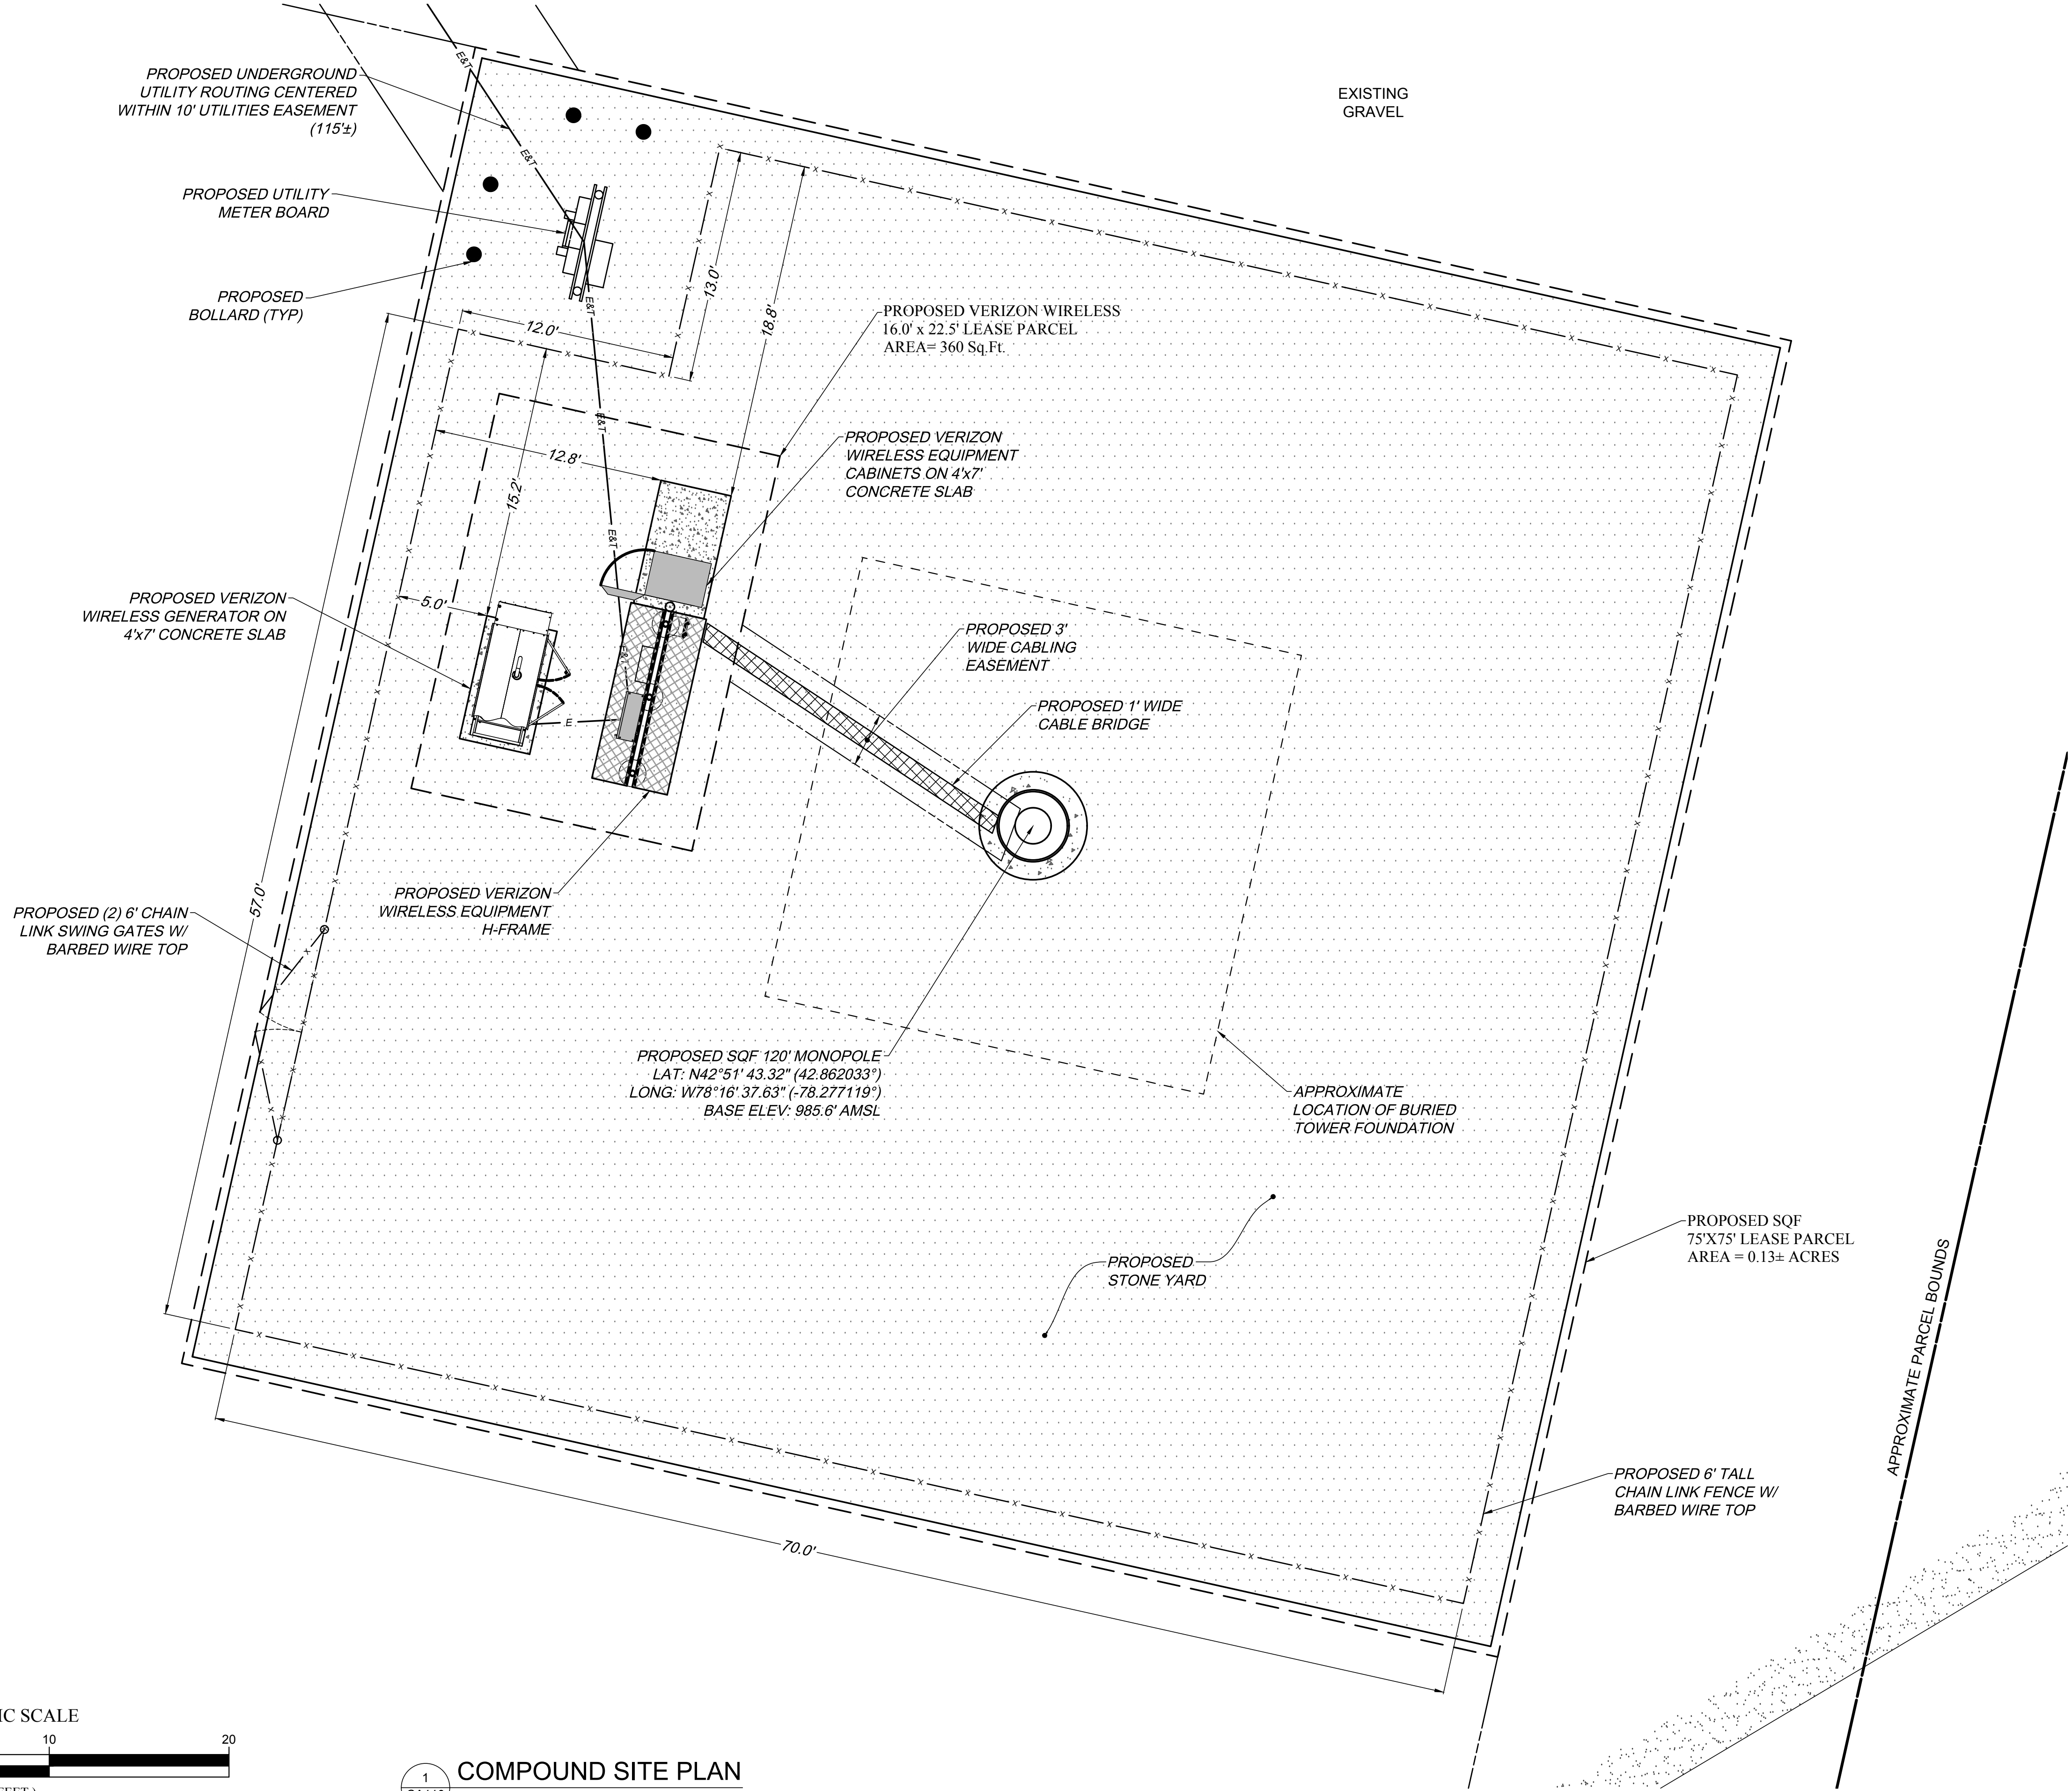

1275 JOHN STREET, SUITE #100  
WEST HENRIETTA, NEW YORK 14586

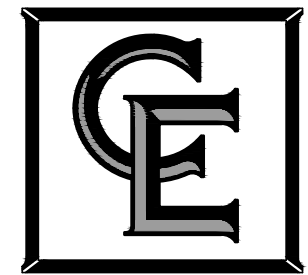

- CIVIL ENGINEERING
- LAND SURVEYING
- LANDSCAPE ARCHITECTURE

217 LAKE AVENUE  
ROCHESTER, NY 14608  
(585) 458-3020

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SITE INFORMATION

ATTICA  
SITE #: NY 1008

VILLAGE OF ATTICA  
COUNTY OF WYOMING  
STATE OF NEW YORK

SHEET TITLE

COMPOUND SITE PLAN


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7706.01

SHEET NUMBER

CA110

SHEET 06 OF 11

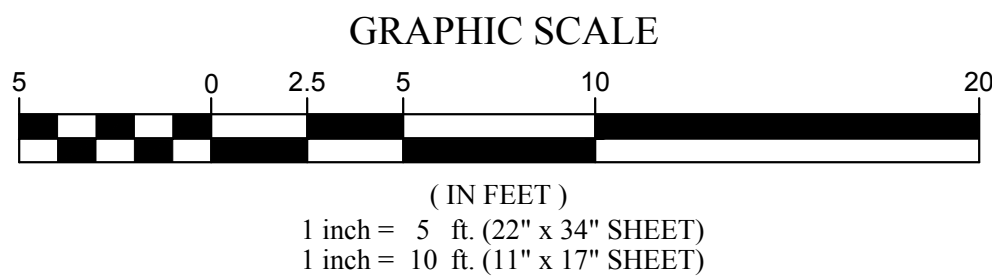


1  
CA110

COMPOUND SITE PLAN

SCALE: 1" = 5' (22 x 34 SHEET)  
1" = 10' (11 x 17 SHEET)



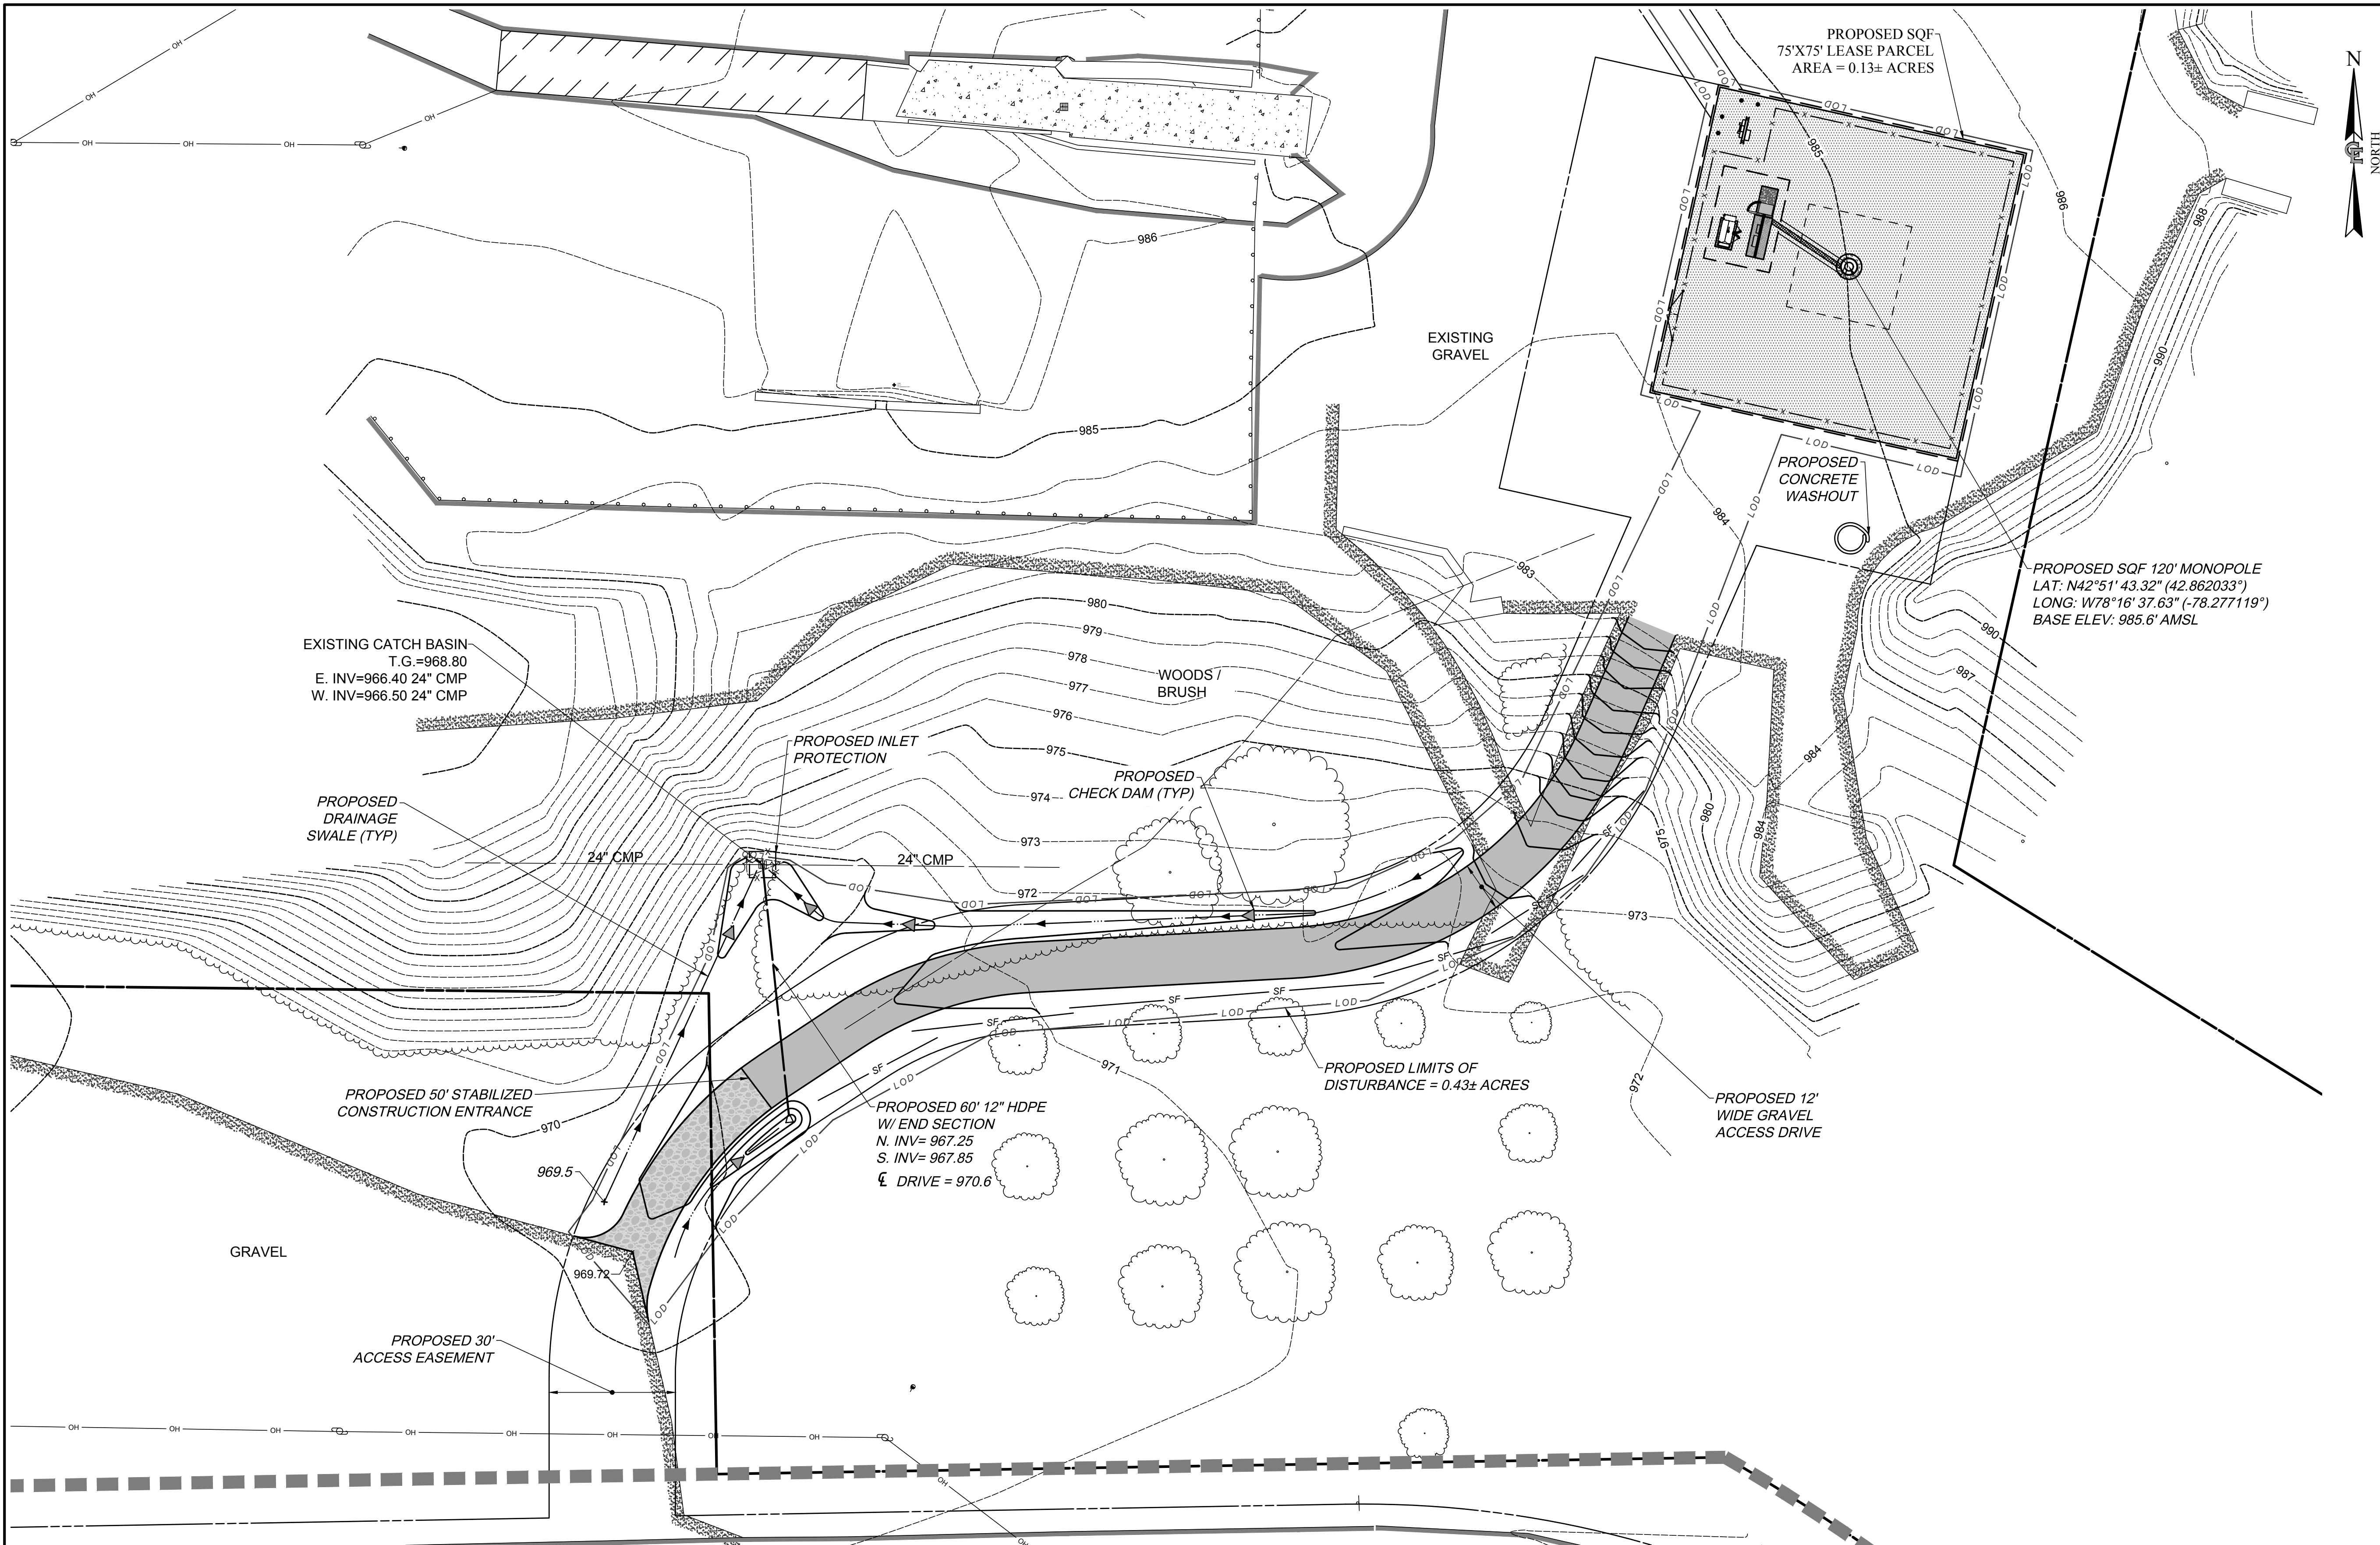

1275 JOHN STREET, SUITE #100  
WEST HENRIETTA, NEW YORK 14586




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(585) 458-3020

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PROJECT MANAGER  
**D.A.W.**

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**T.K.W.**

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SITE INFORMATION

**ATTICA**  
SITE #: NY 1008

VILLAGE OF ATTICA  
COUNTY OF WYOMING  
STATE OF NEW YORK

SHEET TITLE

GRADING & EROSION  
CONTROL PLAN


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**7706.01**

SHEET NUMBER  
**CA120**


SHEET 07 OF 11




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CA120  
**GRADING & EROSION CONTROL PLAN**  
SCALE: 1" = 20' (22 x 34 SHEET)  
1" = 40' (11 x 17 SHEET)

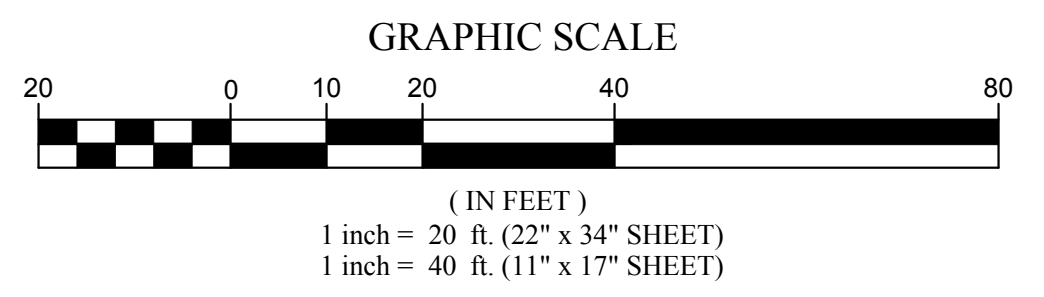



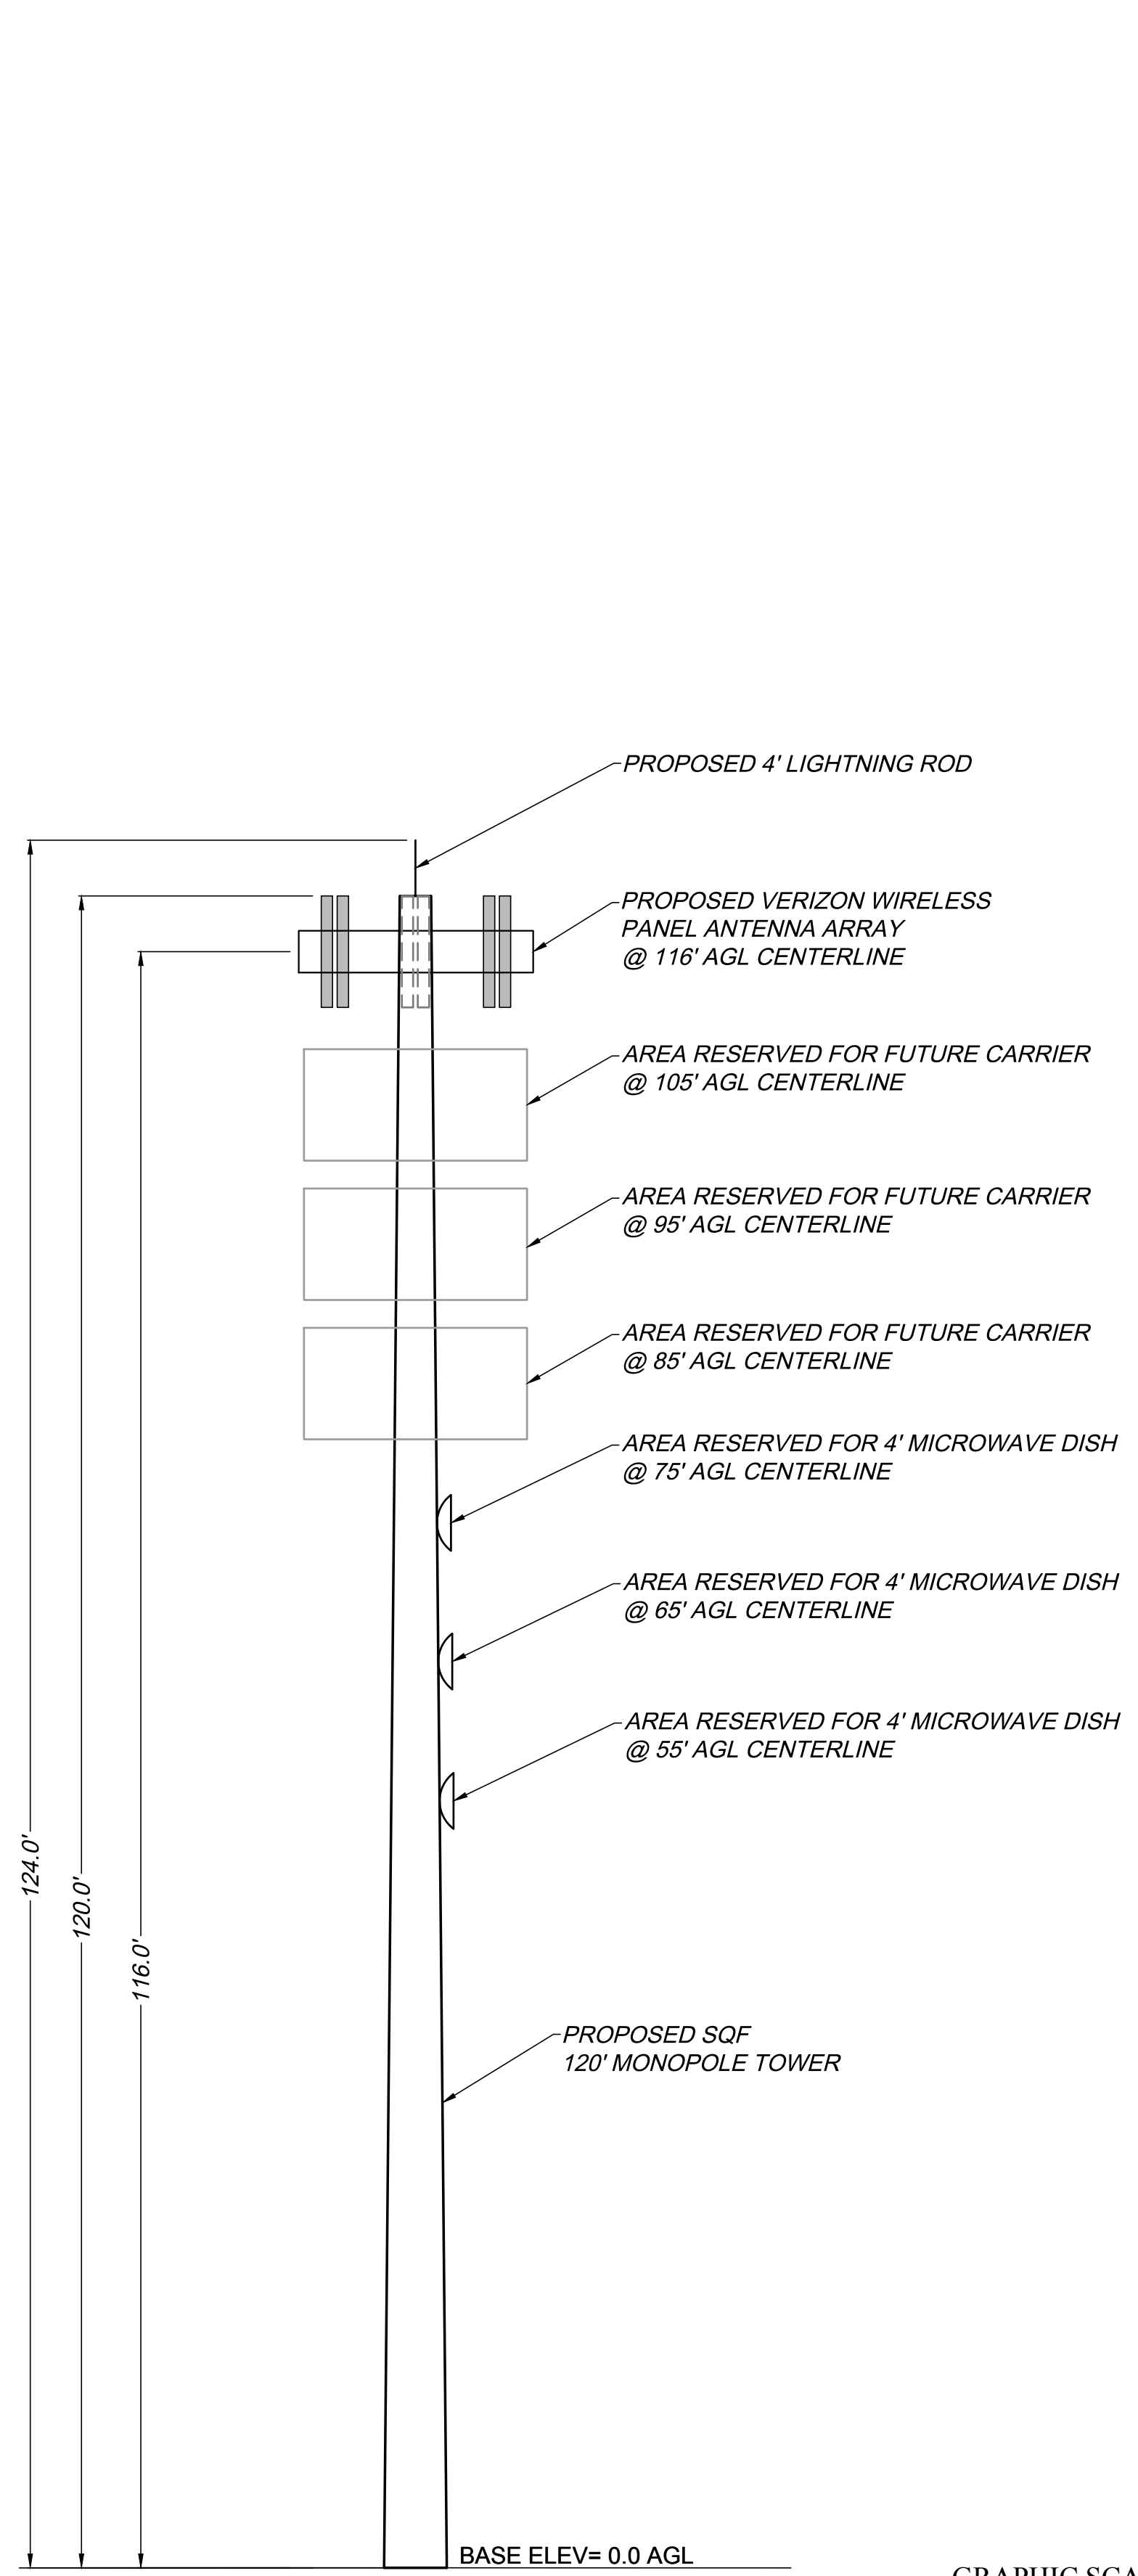


1  
CA500  
TOWER ELEVATION  
SCALE: 1" = 10' (22 x 34 SHEET)  
1" = 20' (11 x 17 SHEET)

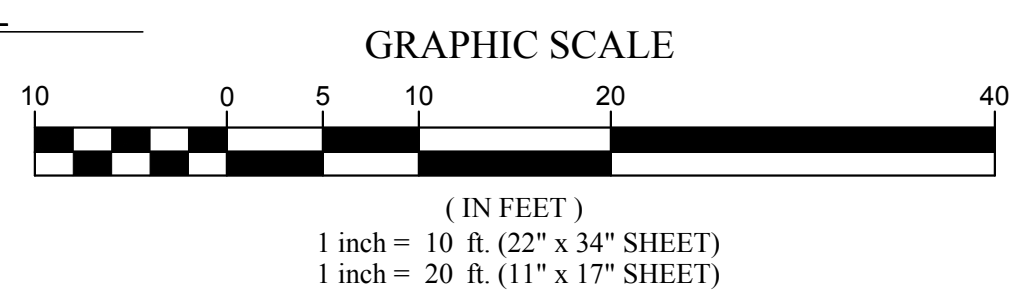


1. THE TOWER SHALL BE CONSTRUCTED WITH GALVANIZED STEEL.
2. NO FAA OBSTRUCTION LIGHTING IS PROPOSED BY SFQ, LLC UNLESS IT IS REQUIRED BY THE FEDERAL AVIATION ADMINISTRATION OR THE LOCAL MUNICIPALITY.
3. ALL REFERENCES TO THE TOWER AND ITS FOUNDATION ARE TO BE DIRECTED TO THE DESIGN AND DETAIL DRAWINGS BY THE TOWER SUPPLIER.
4. THERE SHALL BE NO PERMANENT CLIMBING PEGS WITHIN 15' OF THE GROUND OF ANY TOWER.
5. PROPOSED ANTENNAS SHALL BE INSTALLED IN ACCORDANCE WITH THE SITE SPECIFIC RF ANTENNA DESIGN SHEET SUPPLIED BY THE RF SYSTEMS ENGINEER.


BOOM MOUNT DESIGN OBTAINED FROM A DRAWING BY ARMOR TOWER, TITLED "6' BOOM" SHEET #S-1, DATED 04/17/18  
NSTD-445 CLASSIFICATION: M900R(1150)-4[6]

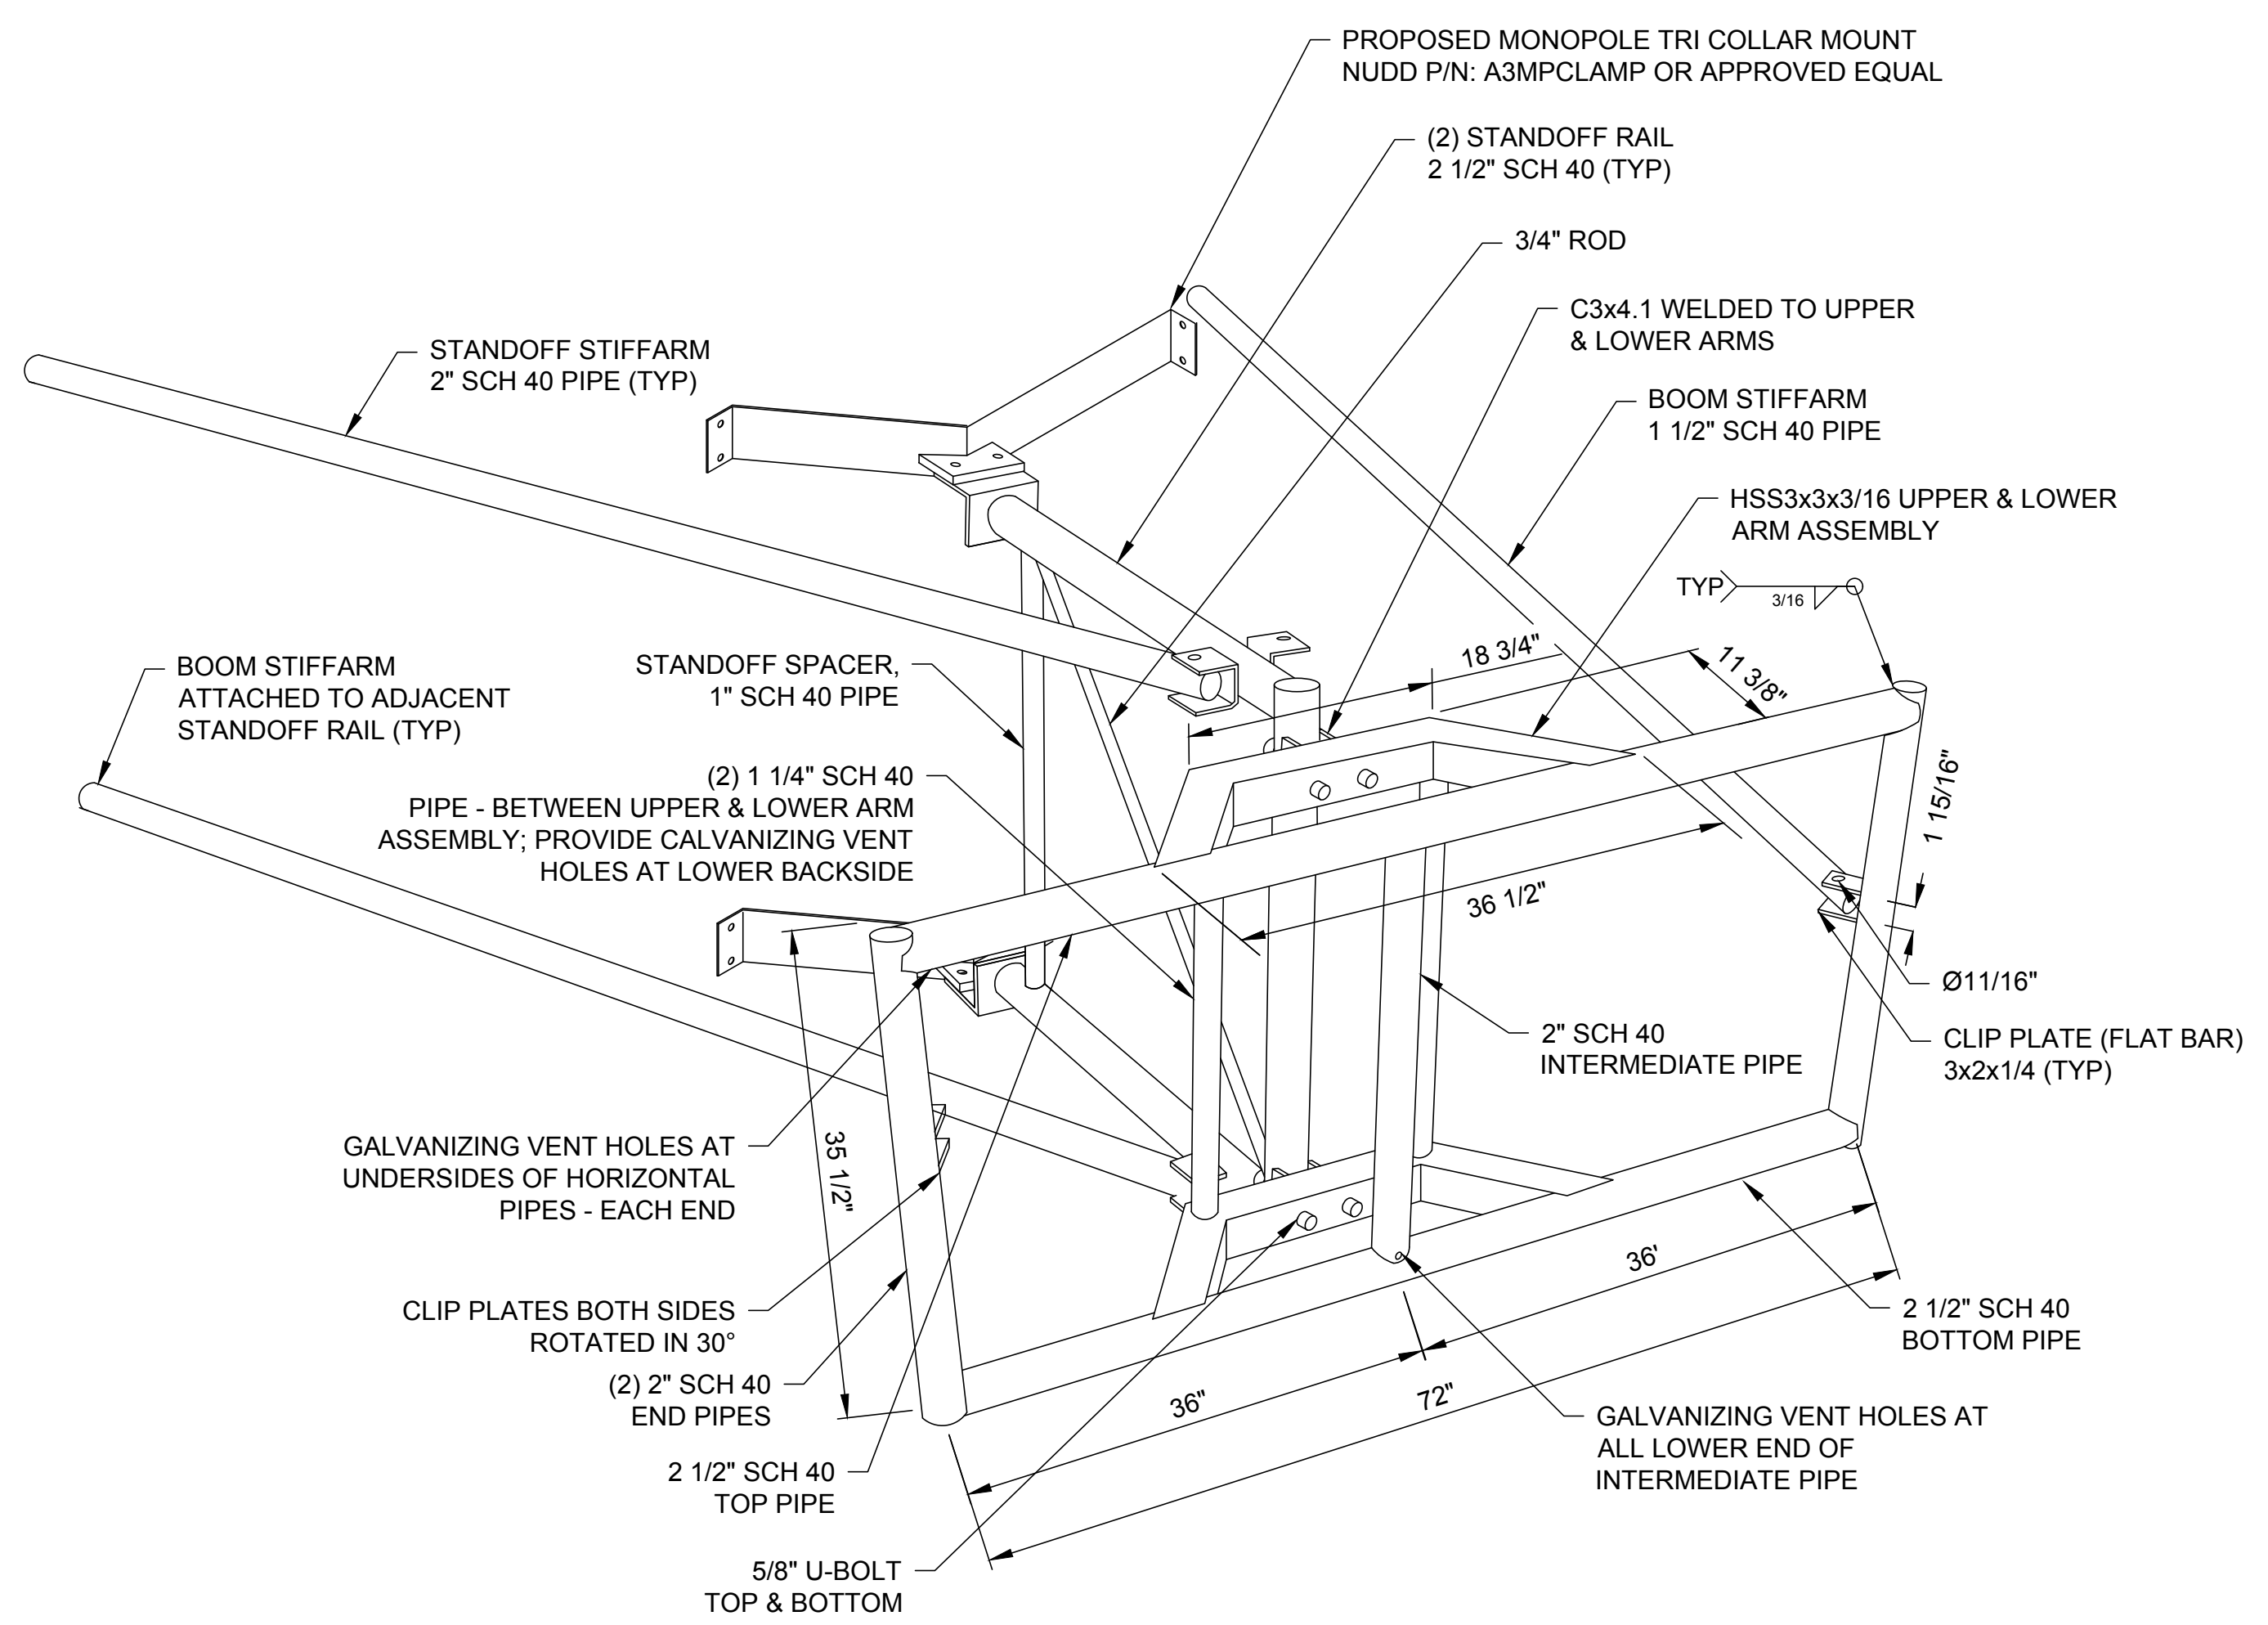


2  
CA500  
BOOM MOUNT DETAIL  
SCALE: NTS

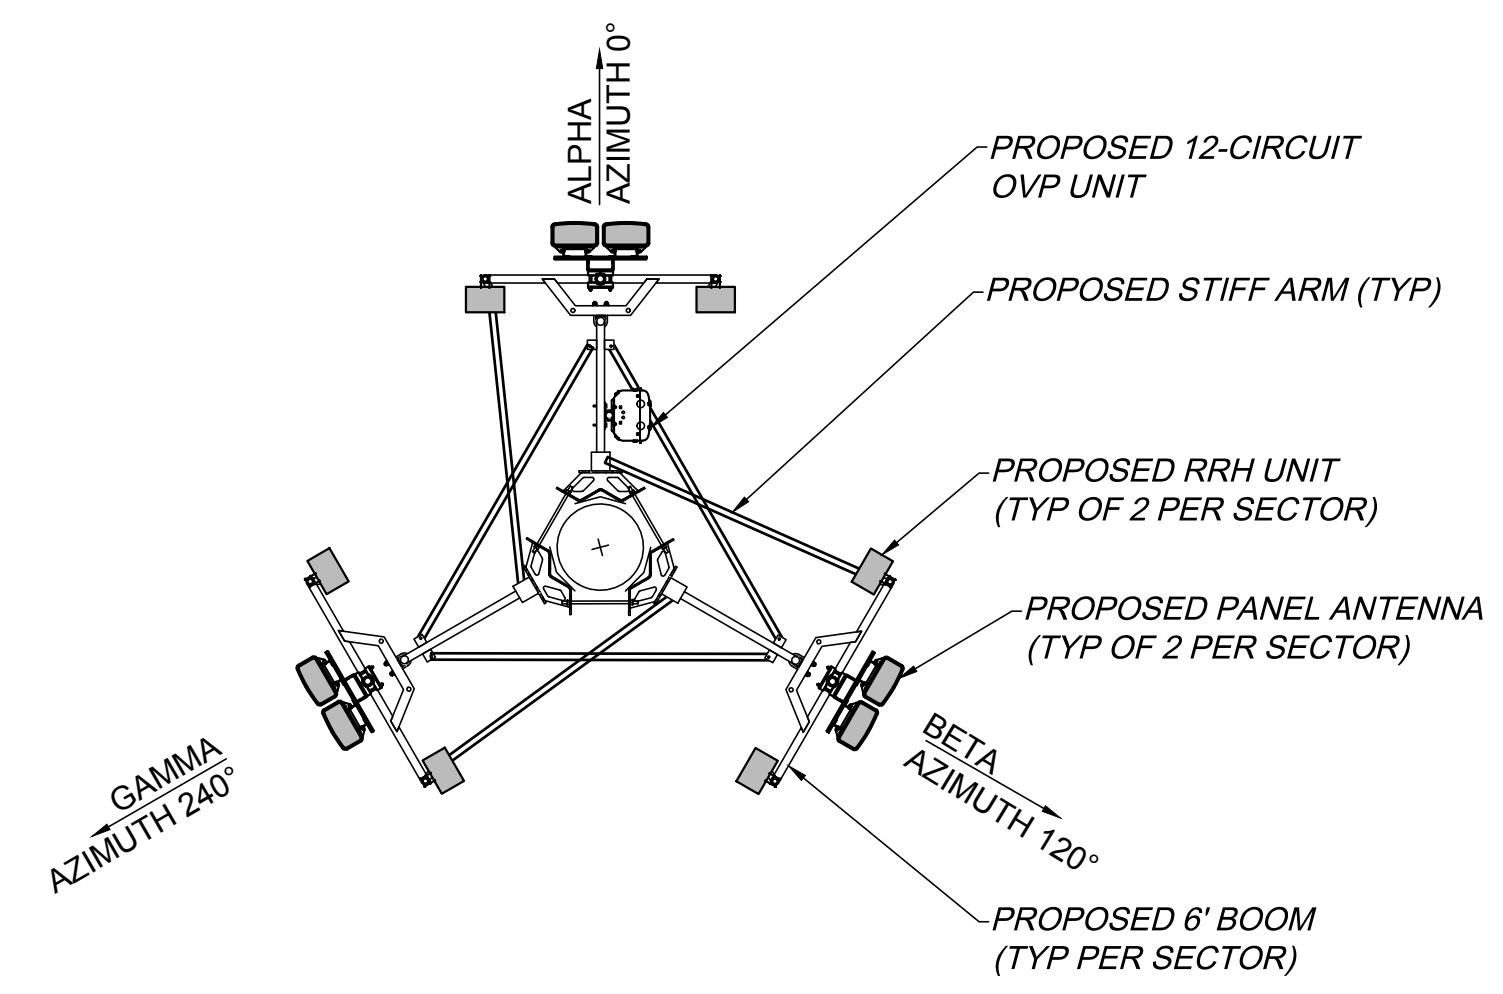

3  
CA500  
ANTENNA ORIENTATION  
SCALE: 1" = 5' (22 x 34 SHEET)  
1" = 10' (11 x 17 SHEET)

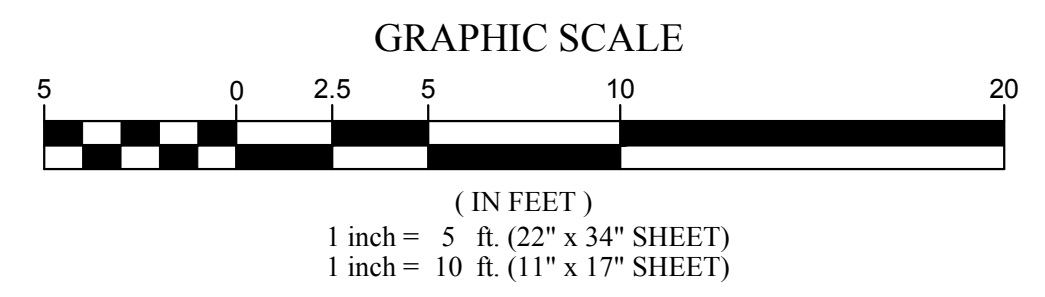

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PROJECT MANAGER  
D.A.W.  
DRAWN BY  
T.K.W.

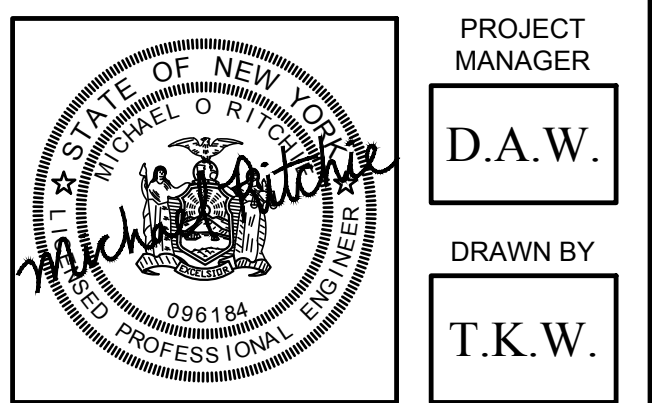
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SITE INFORMATION  
ATTICA  
SITE #: NY 1008




VILLAGE OF ATTICA  
COUNTY OF WYOMING  
STATE OF NEW YORK  
SHEET TITLE

TOWER ELEVATION & ORIENTATION PLAN  
C.E. JOB NUMBER  
7706.01  
SHEET NUMBER  
CA500  
SHEET 08 OF 11



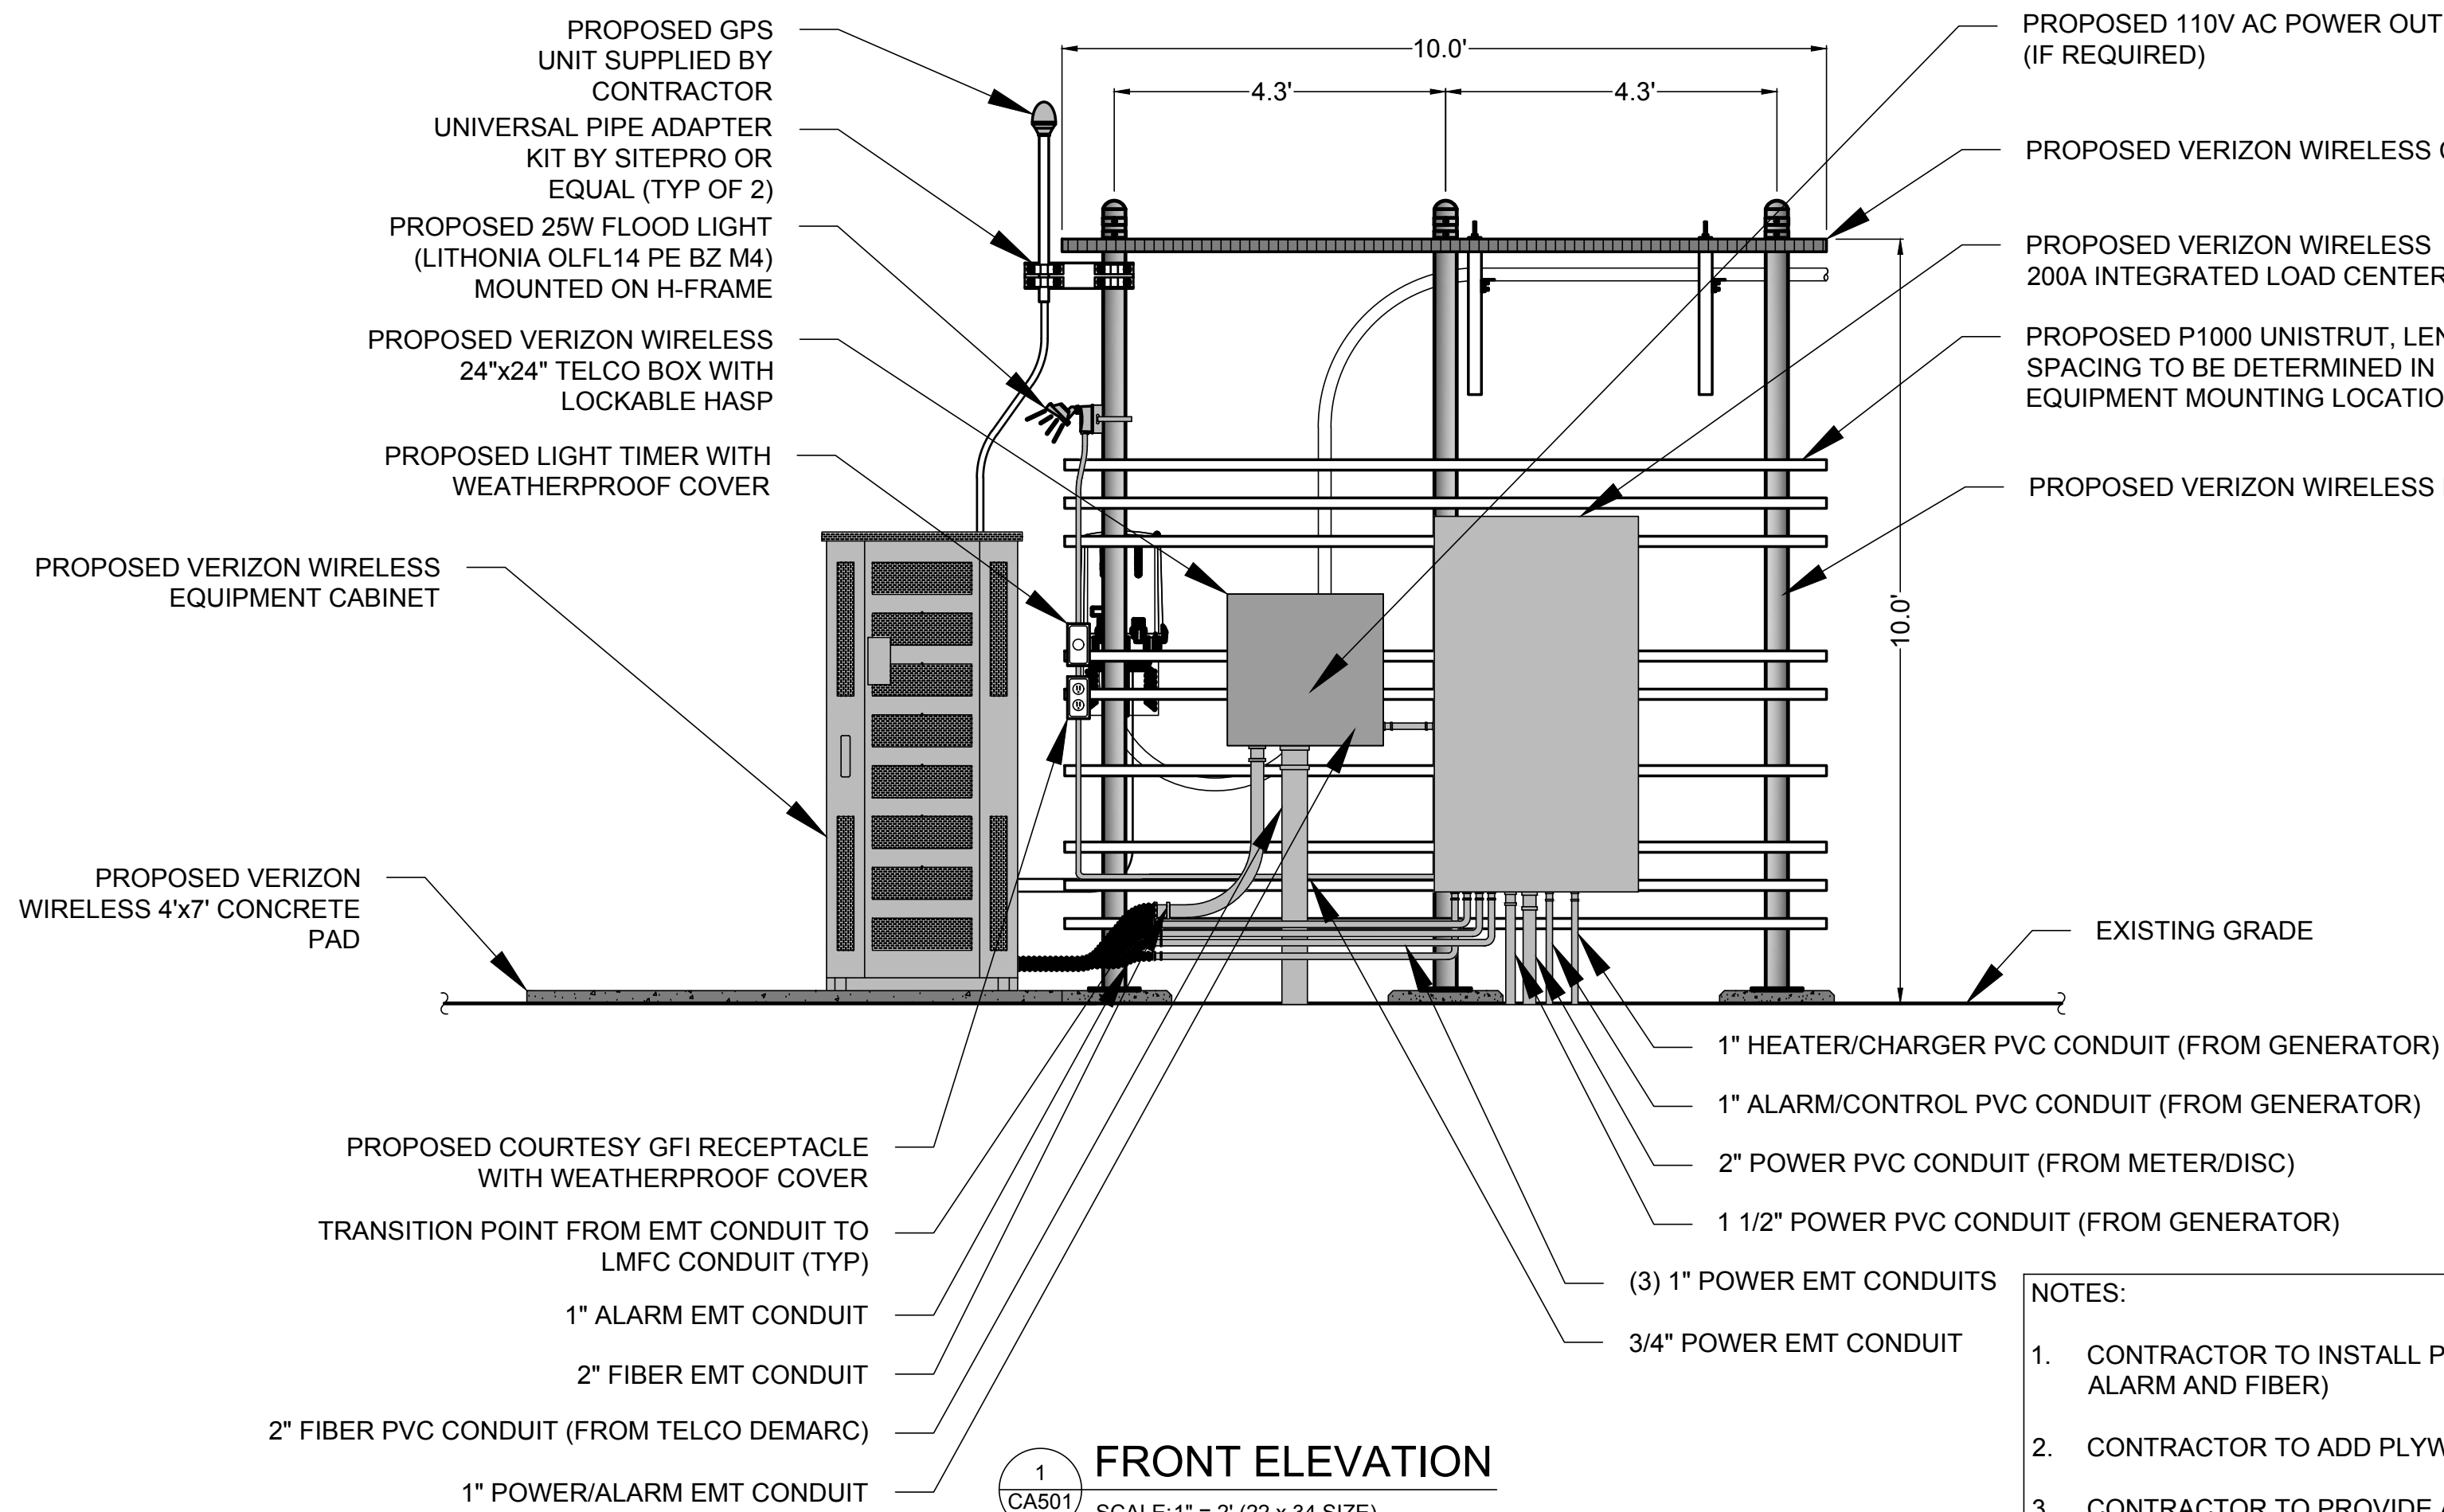


- NOTES:
- CONTRACTOR TO INSTALL PULL STRINGS IN ALL EQUIPMENT CONDUITS (OVP, ALARM AND FIBER)
  - CONTRACTOR TO ADD PLYWOOD BACKING BOARD INSIDE HOFFMAN BOX.
  - CONTRACTOR TO PROVIDE AND INSTALL CAT6 ETHERNET CABLING FOR ALL ALARM POINTS REQUIRED BY VERIZON WIRELESS STANDARDS.
  - ALL CIVIL SITE WORK (CONDUITS, GROUNDING, CONCRETE) TO BE PERFORMED BY VERIZON WIRELESS GENERAL CONTRACTOR. ALL OTHER WORK TO BE DONE BY OTHERS.

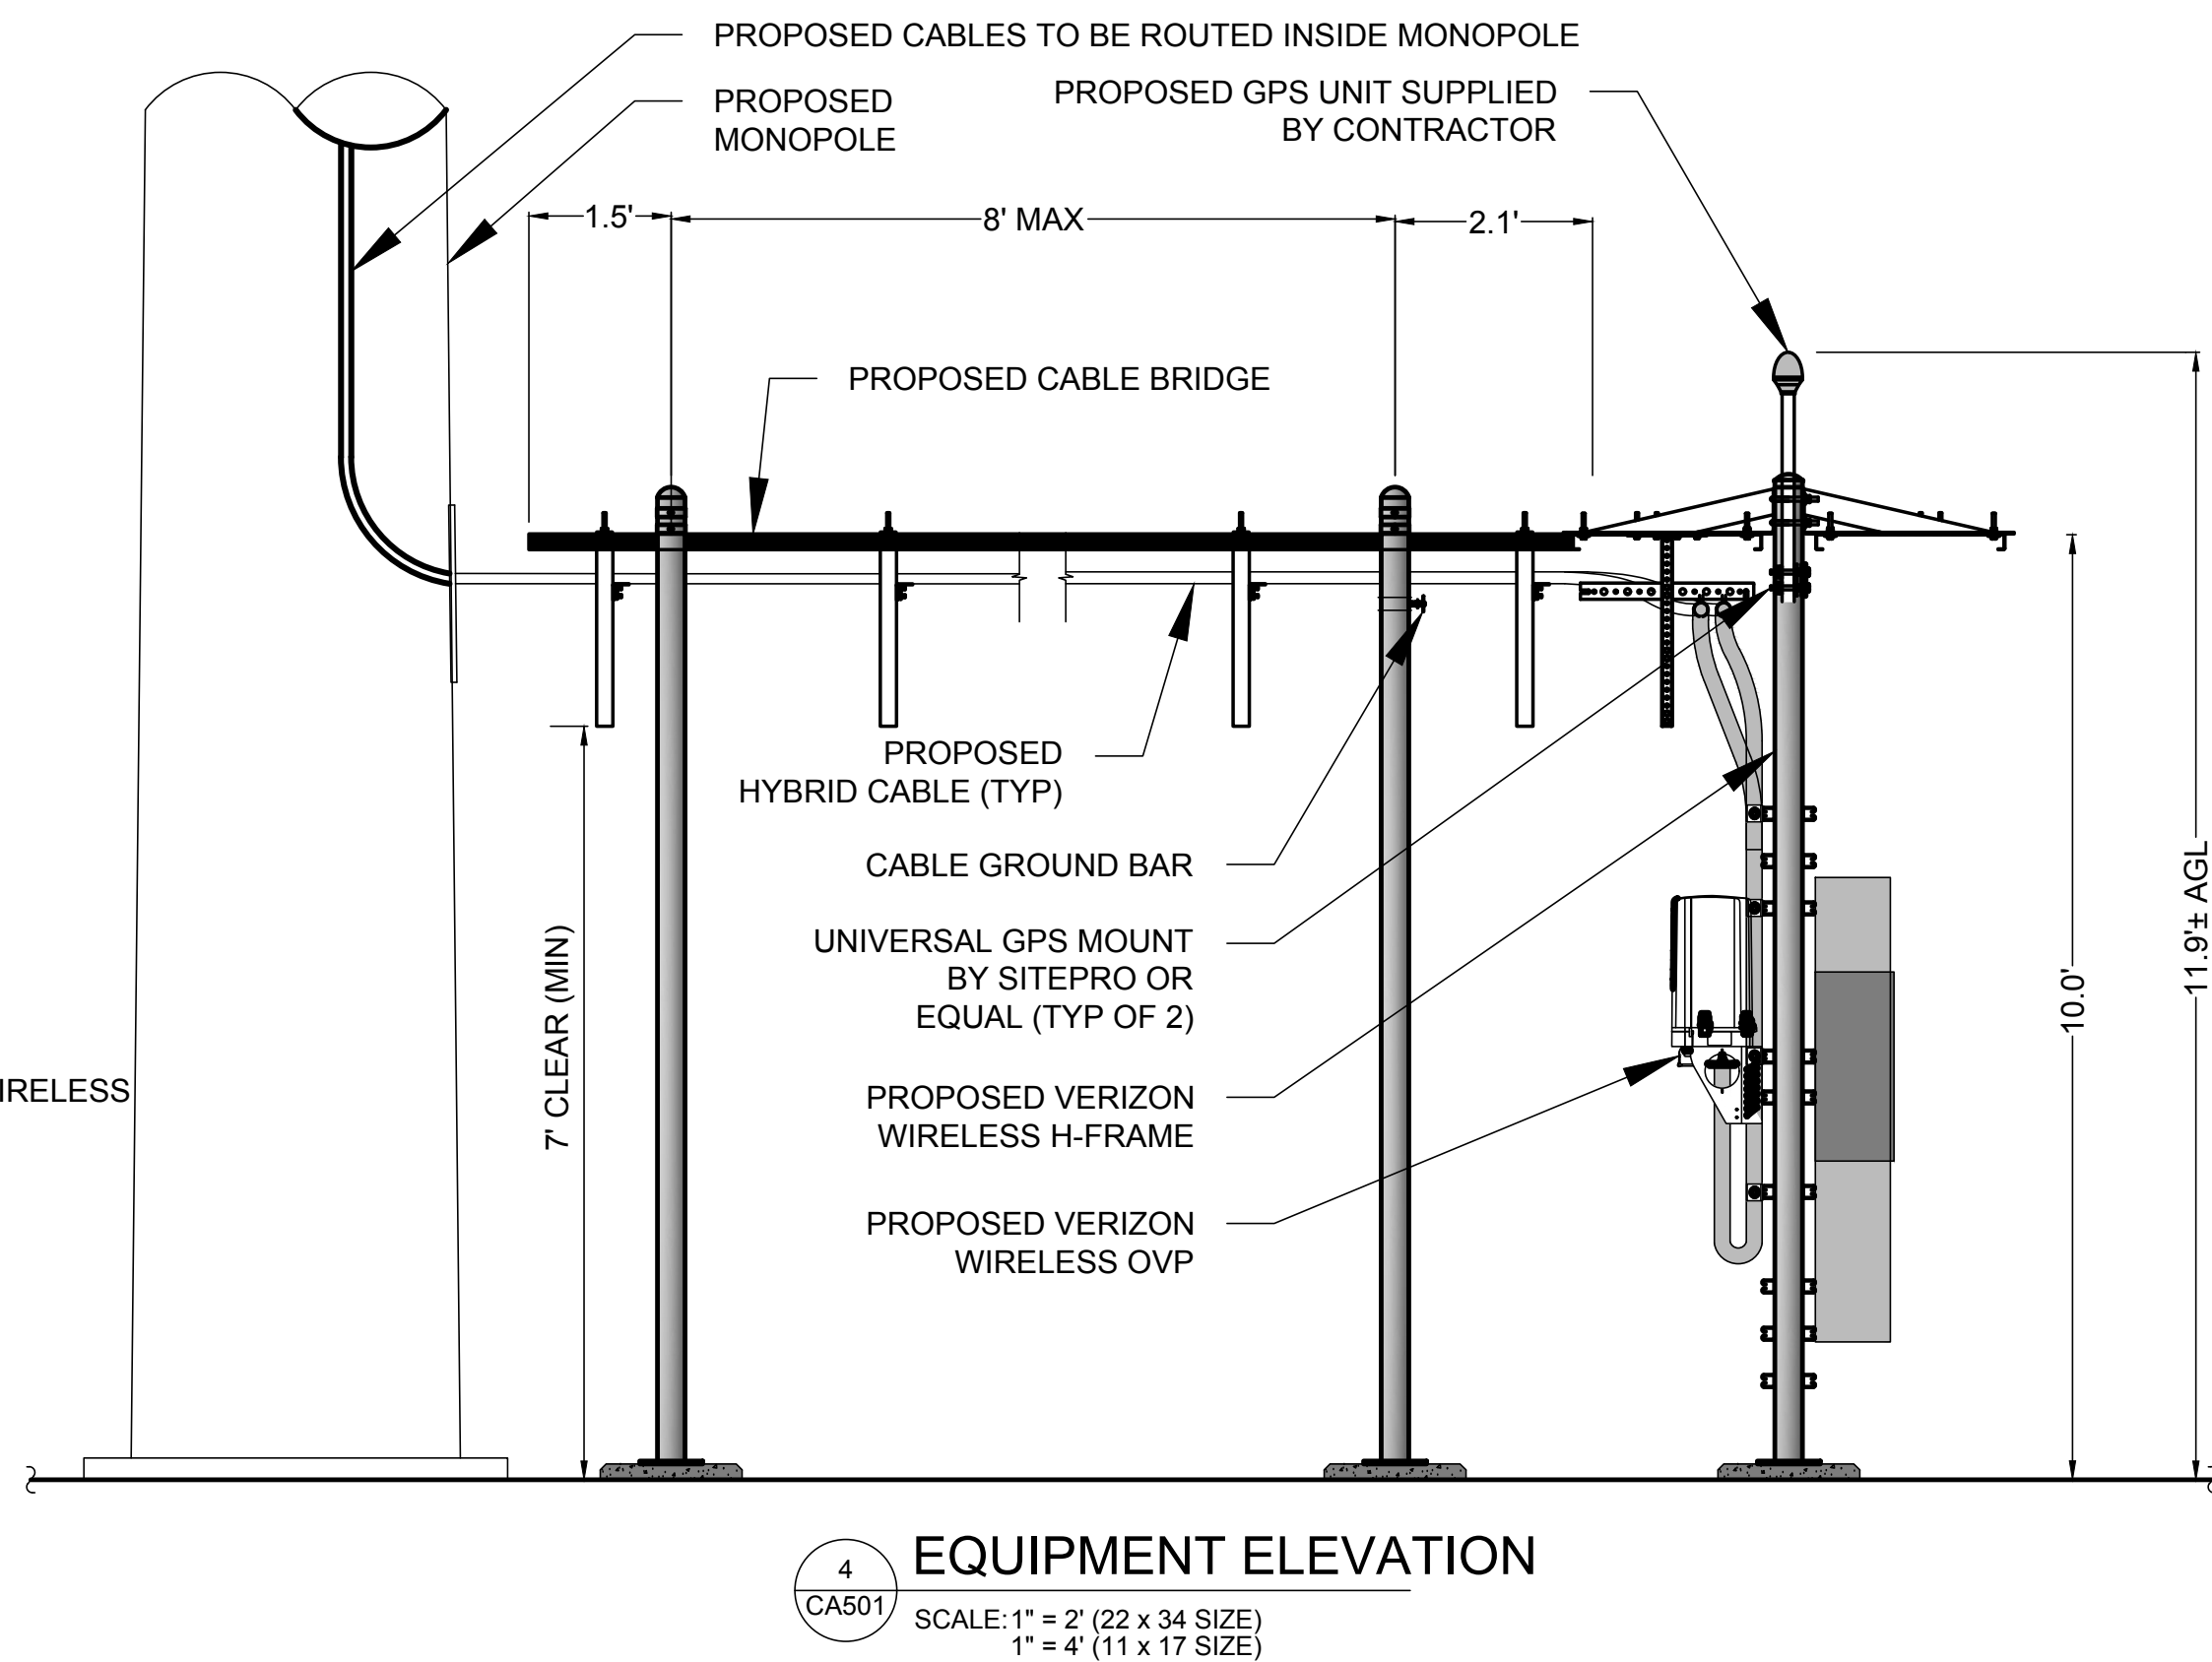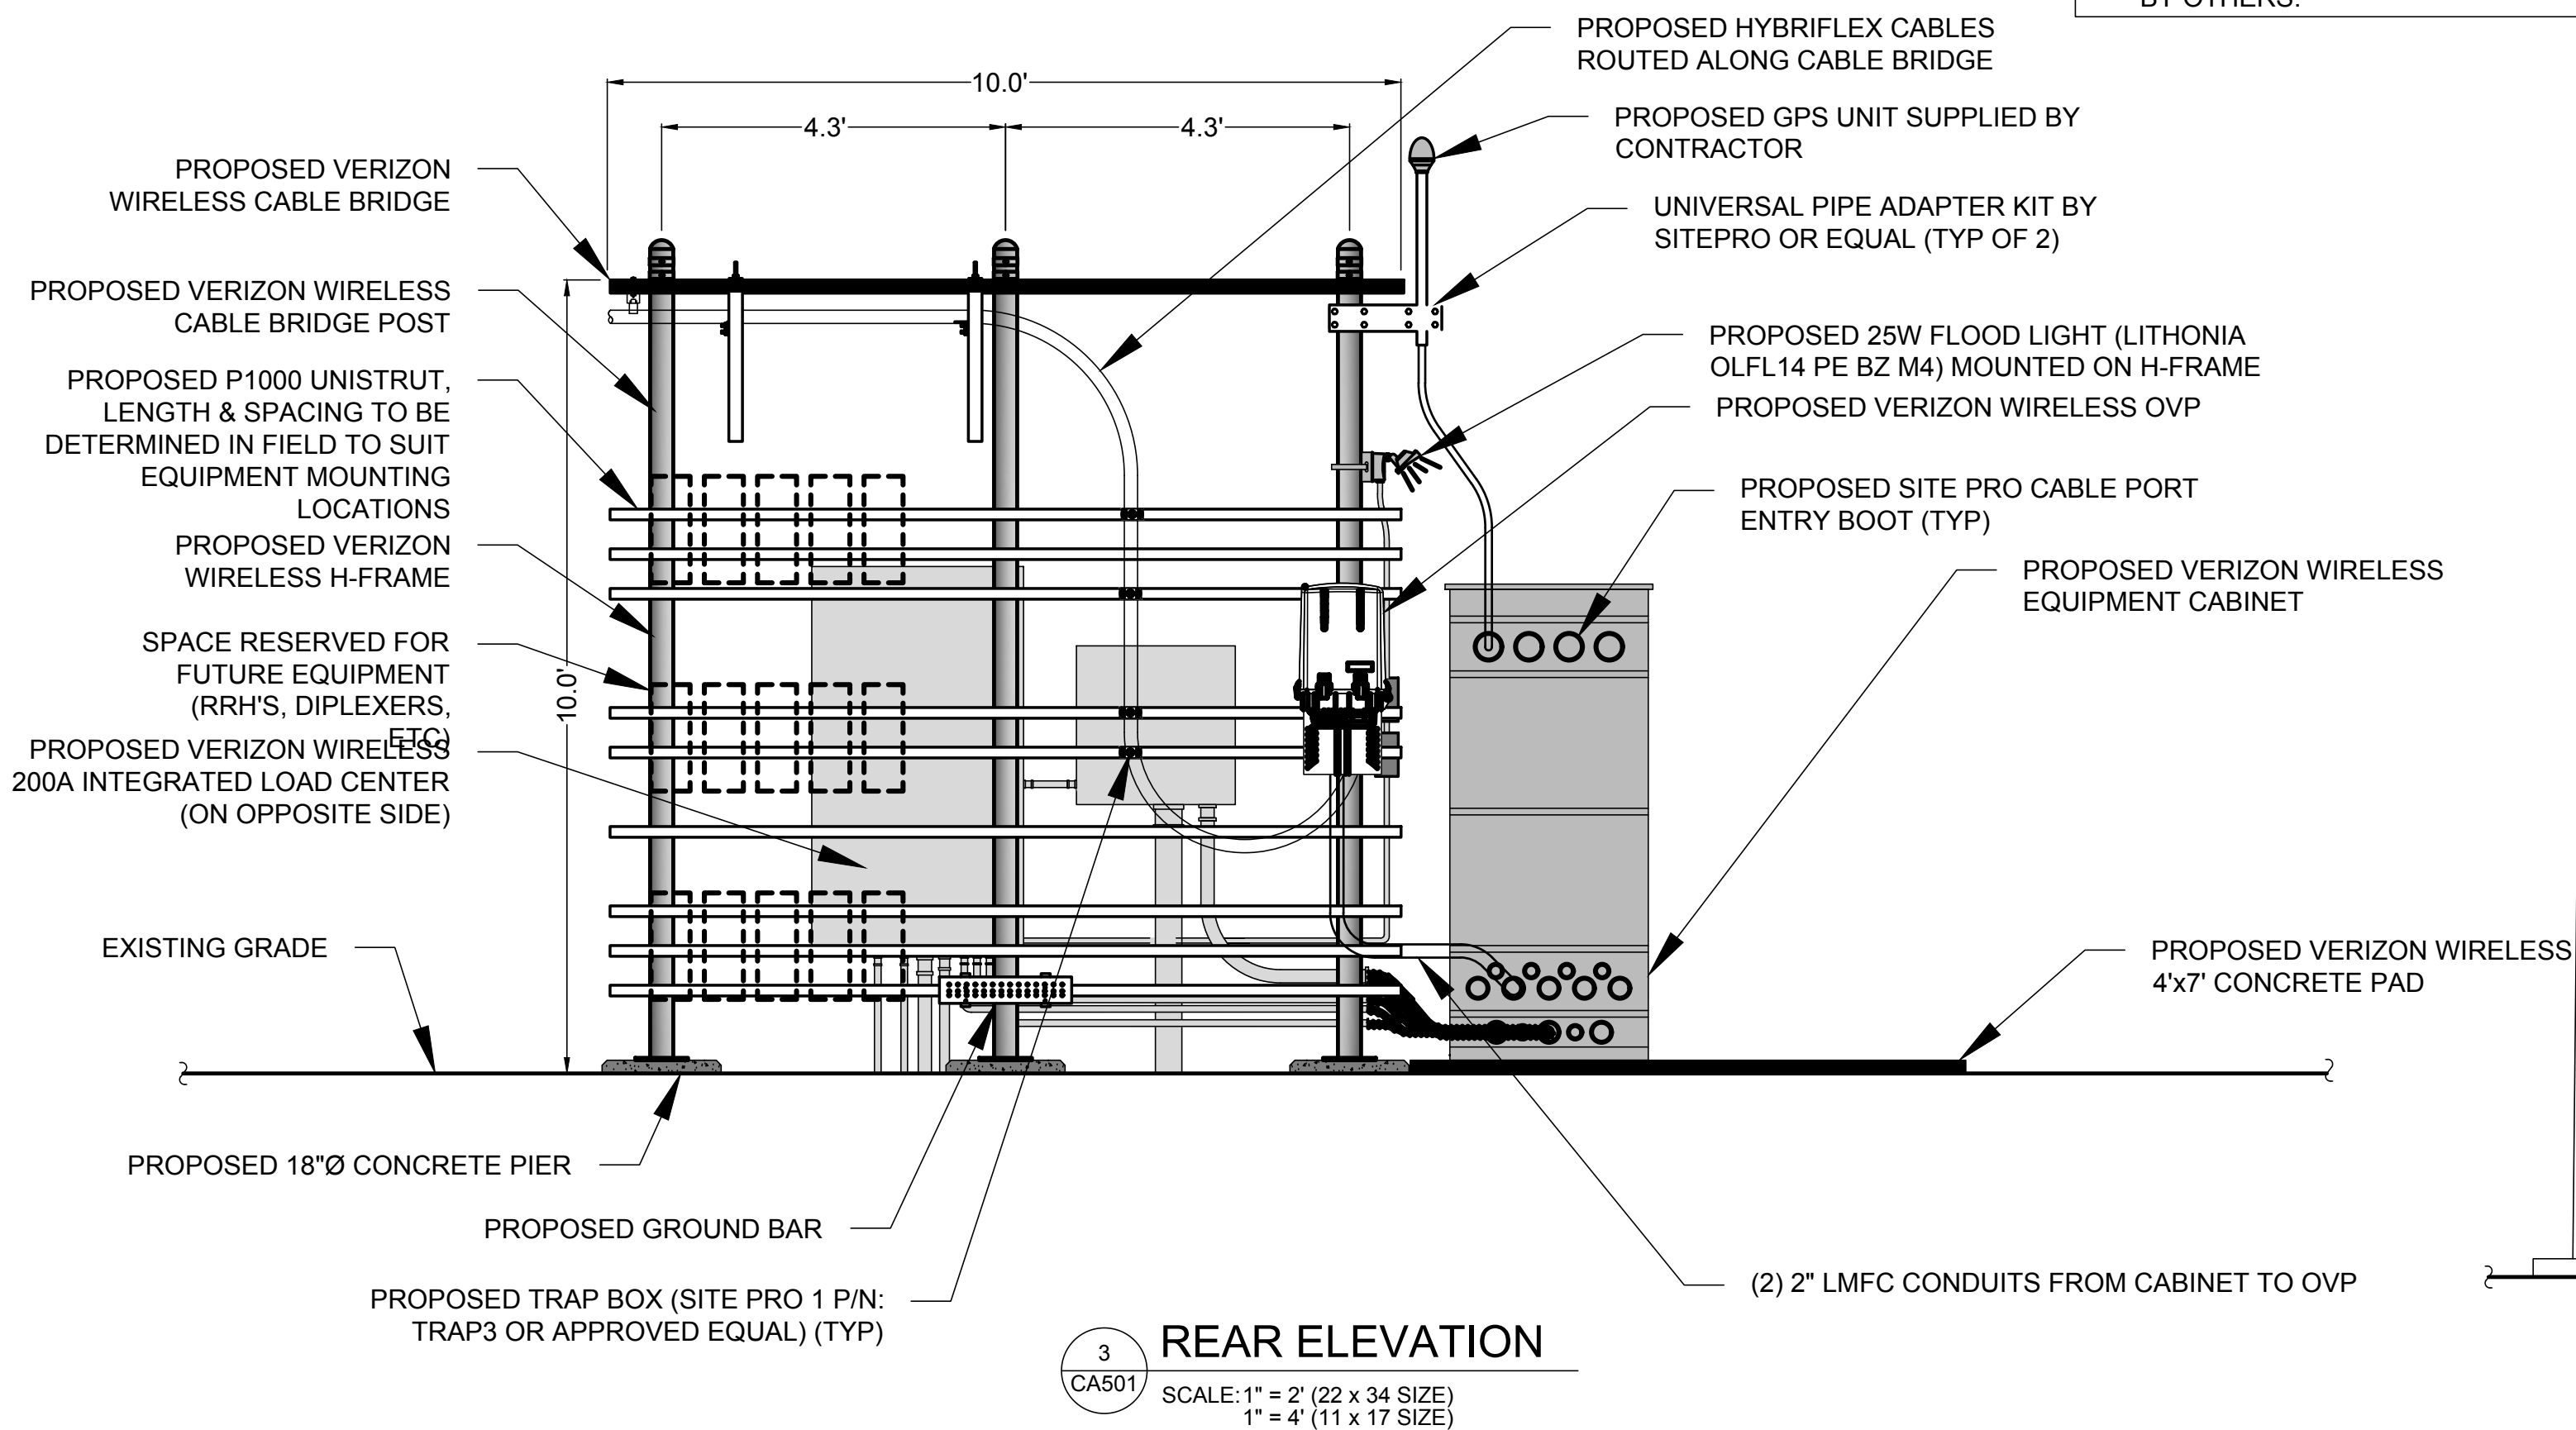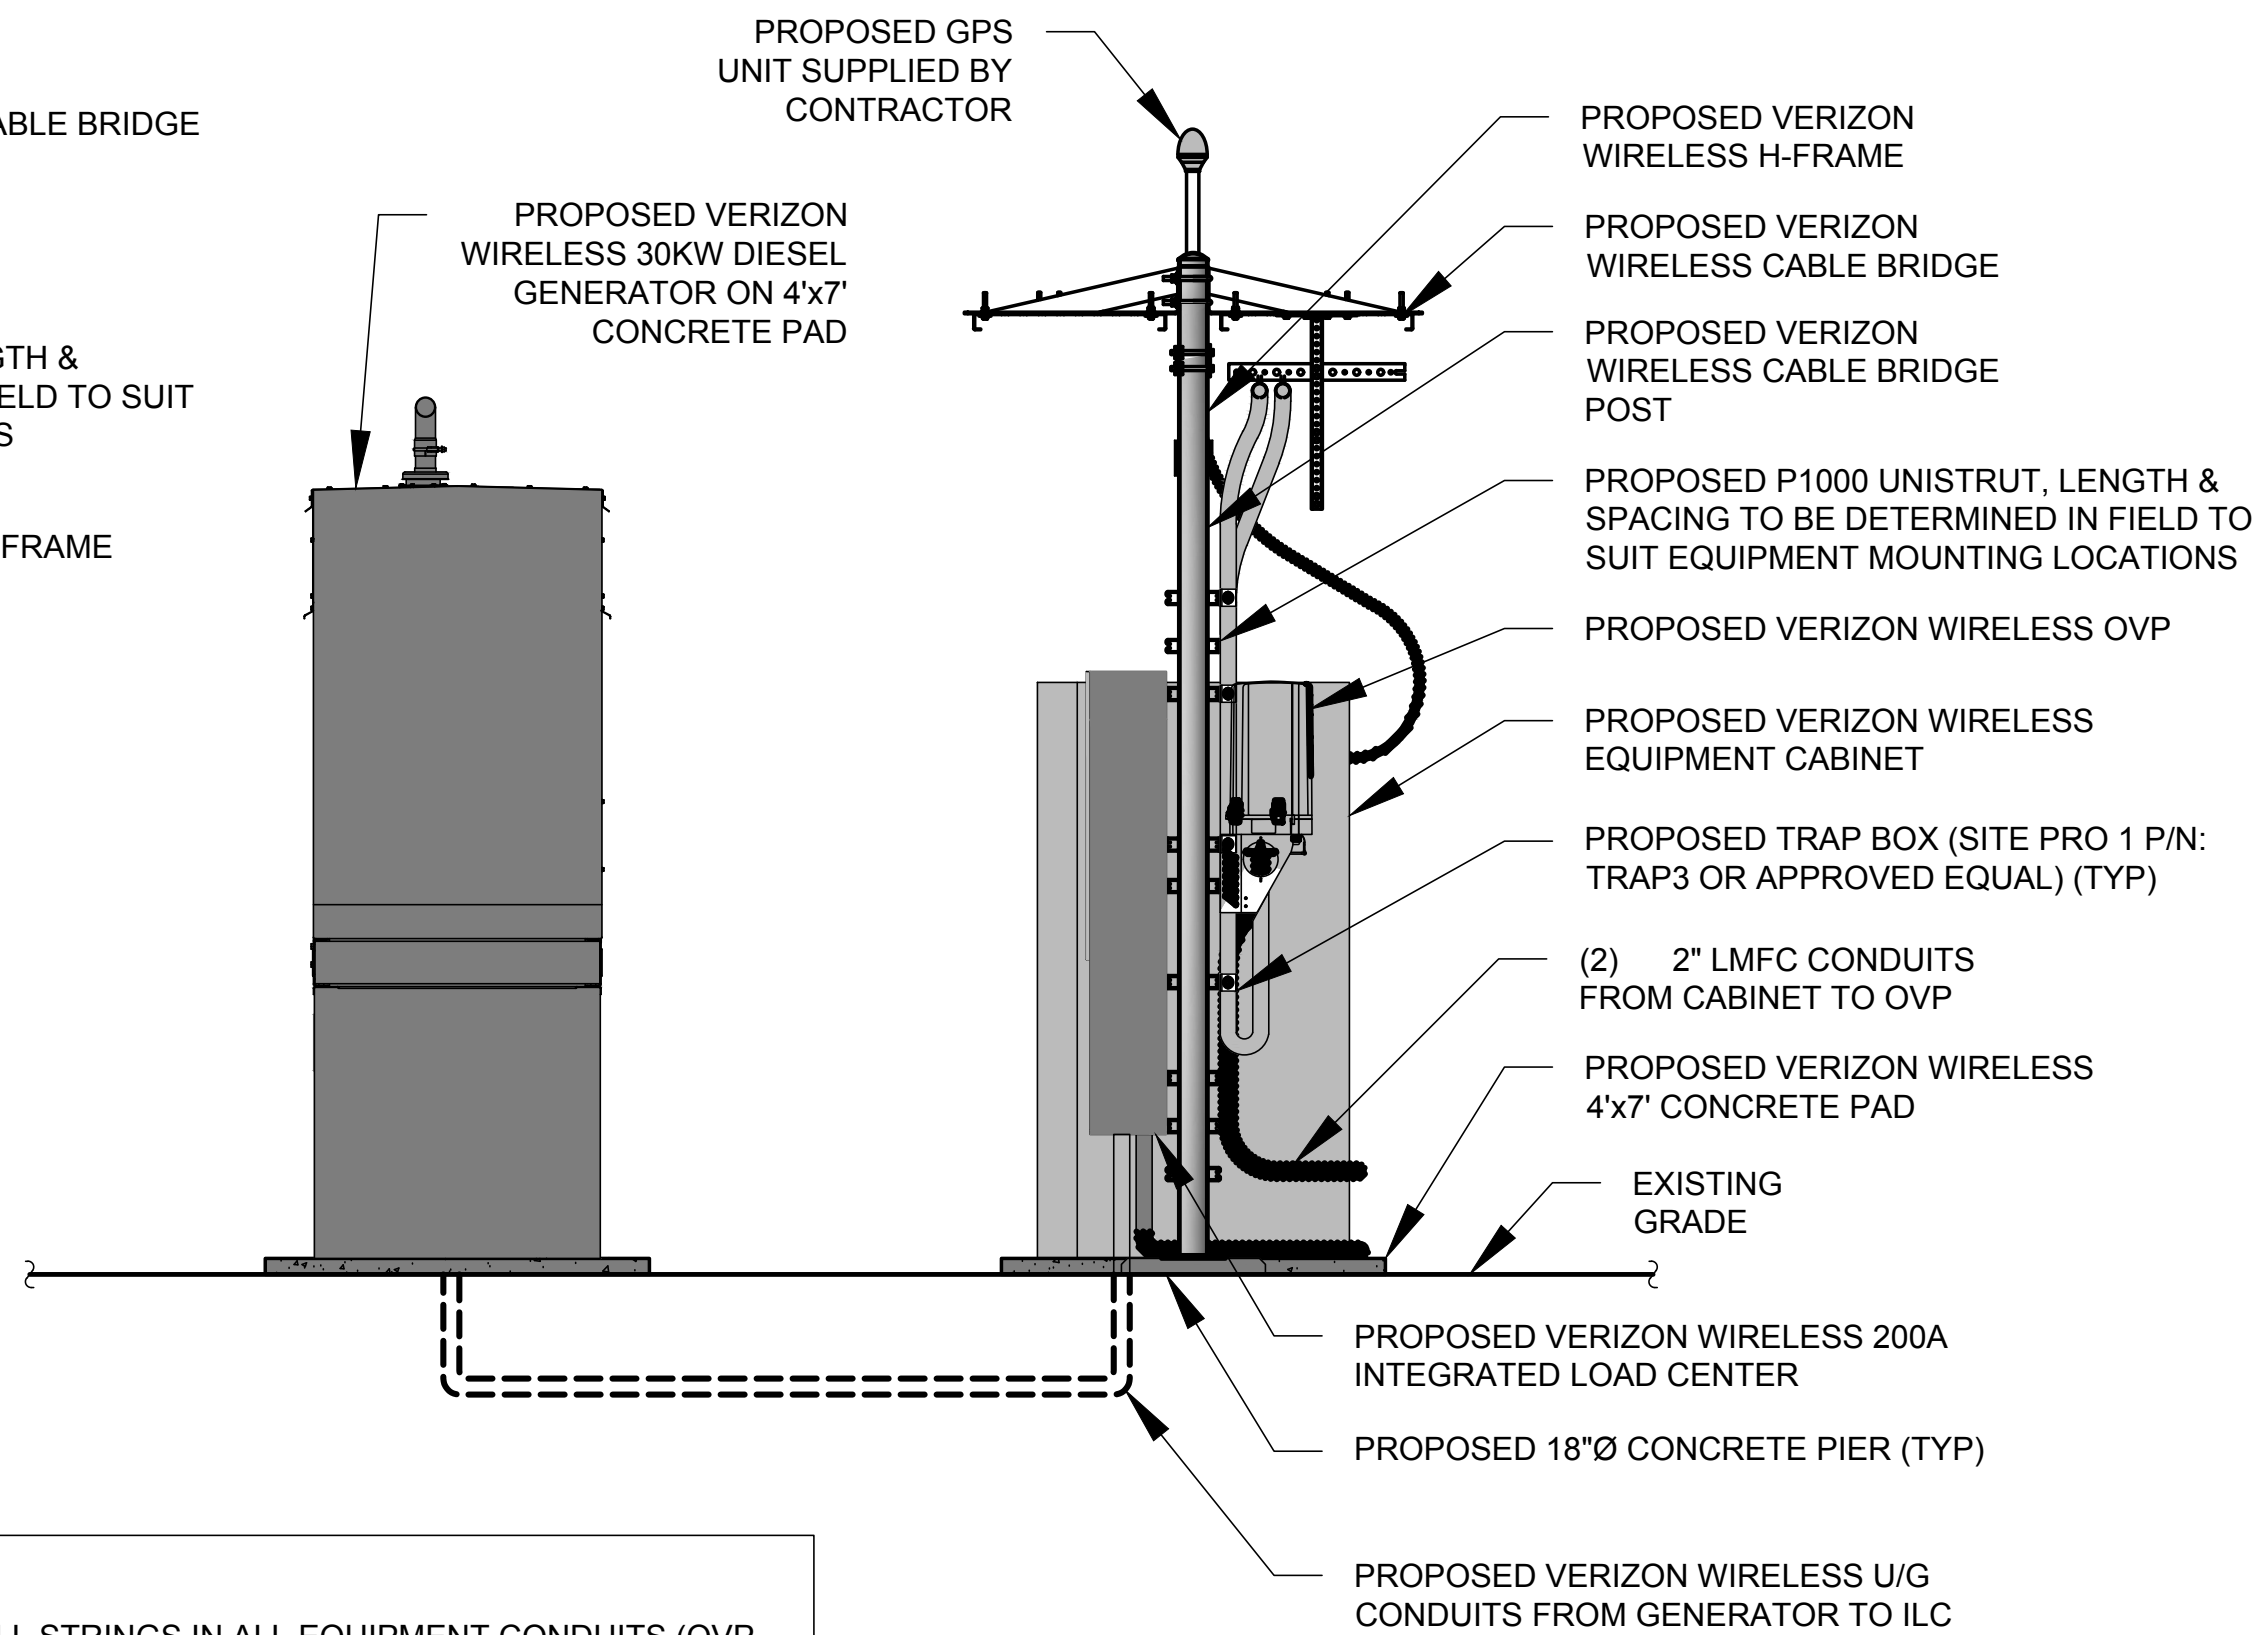

**verizon**

1275 JOHN STREET, SUITE #100  
WEST HENRIETTA, NEW YORK 14586

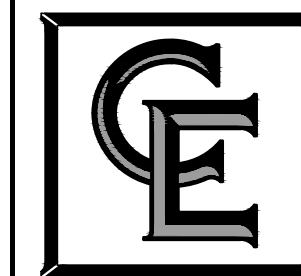

• CIVIL ENGINEERING  
• LAND SURVEYING  
• LANDSCAPE ARCHITECTURE

217 LAKE AVENUE  
ROCHESTER, NY 14608  
(585) 458-3020

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PROJECT MANAGER

D.A.W.

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T.K.W.

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SITE INFORMATION

ATTICA  
SITE #: NY 1008

VILLAGE OF ATTICA  
COUNTY OF WYOMING  
STATE OF NEW YORK

SHEET TITLE

EQUIPMENT  
ELEVATIONS

C.E. JOB NUMBER







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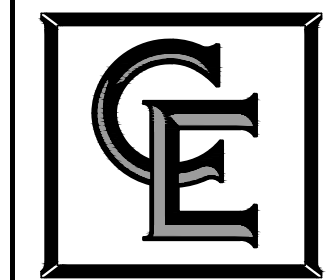
CA501

SHEET 09 OF 11





1275 JOHN STREET, SUITE #100  
WEST HENRIETTA, NEW YORK 14586

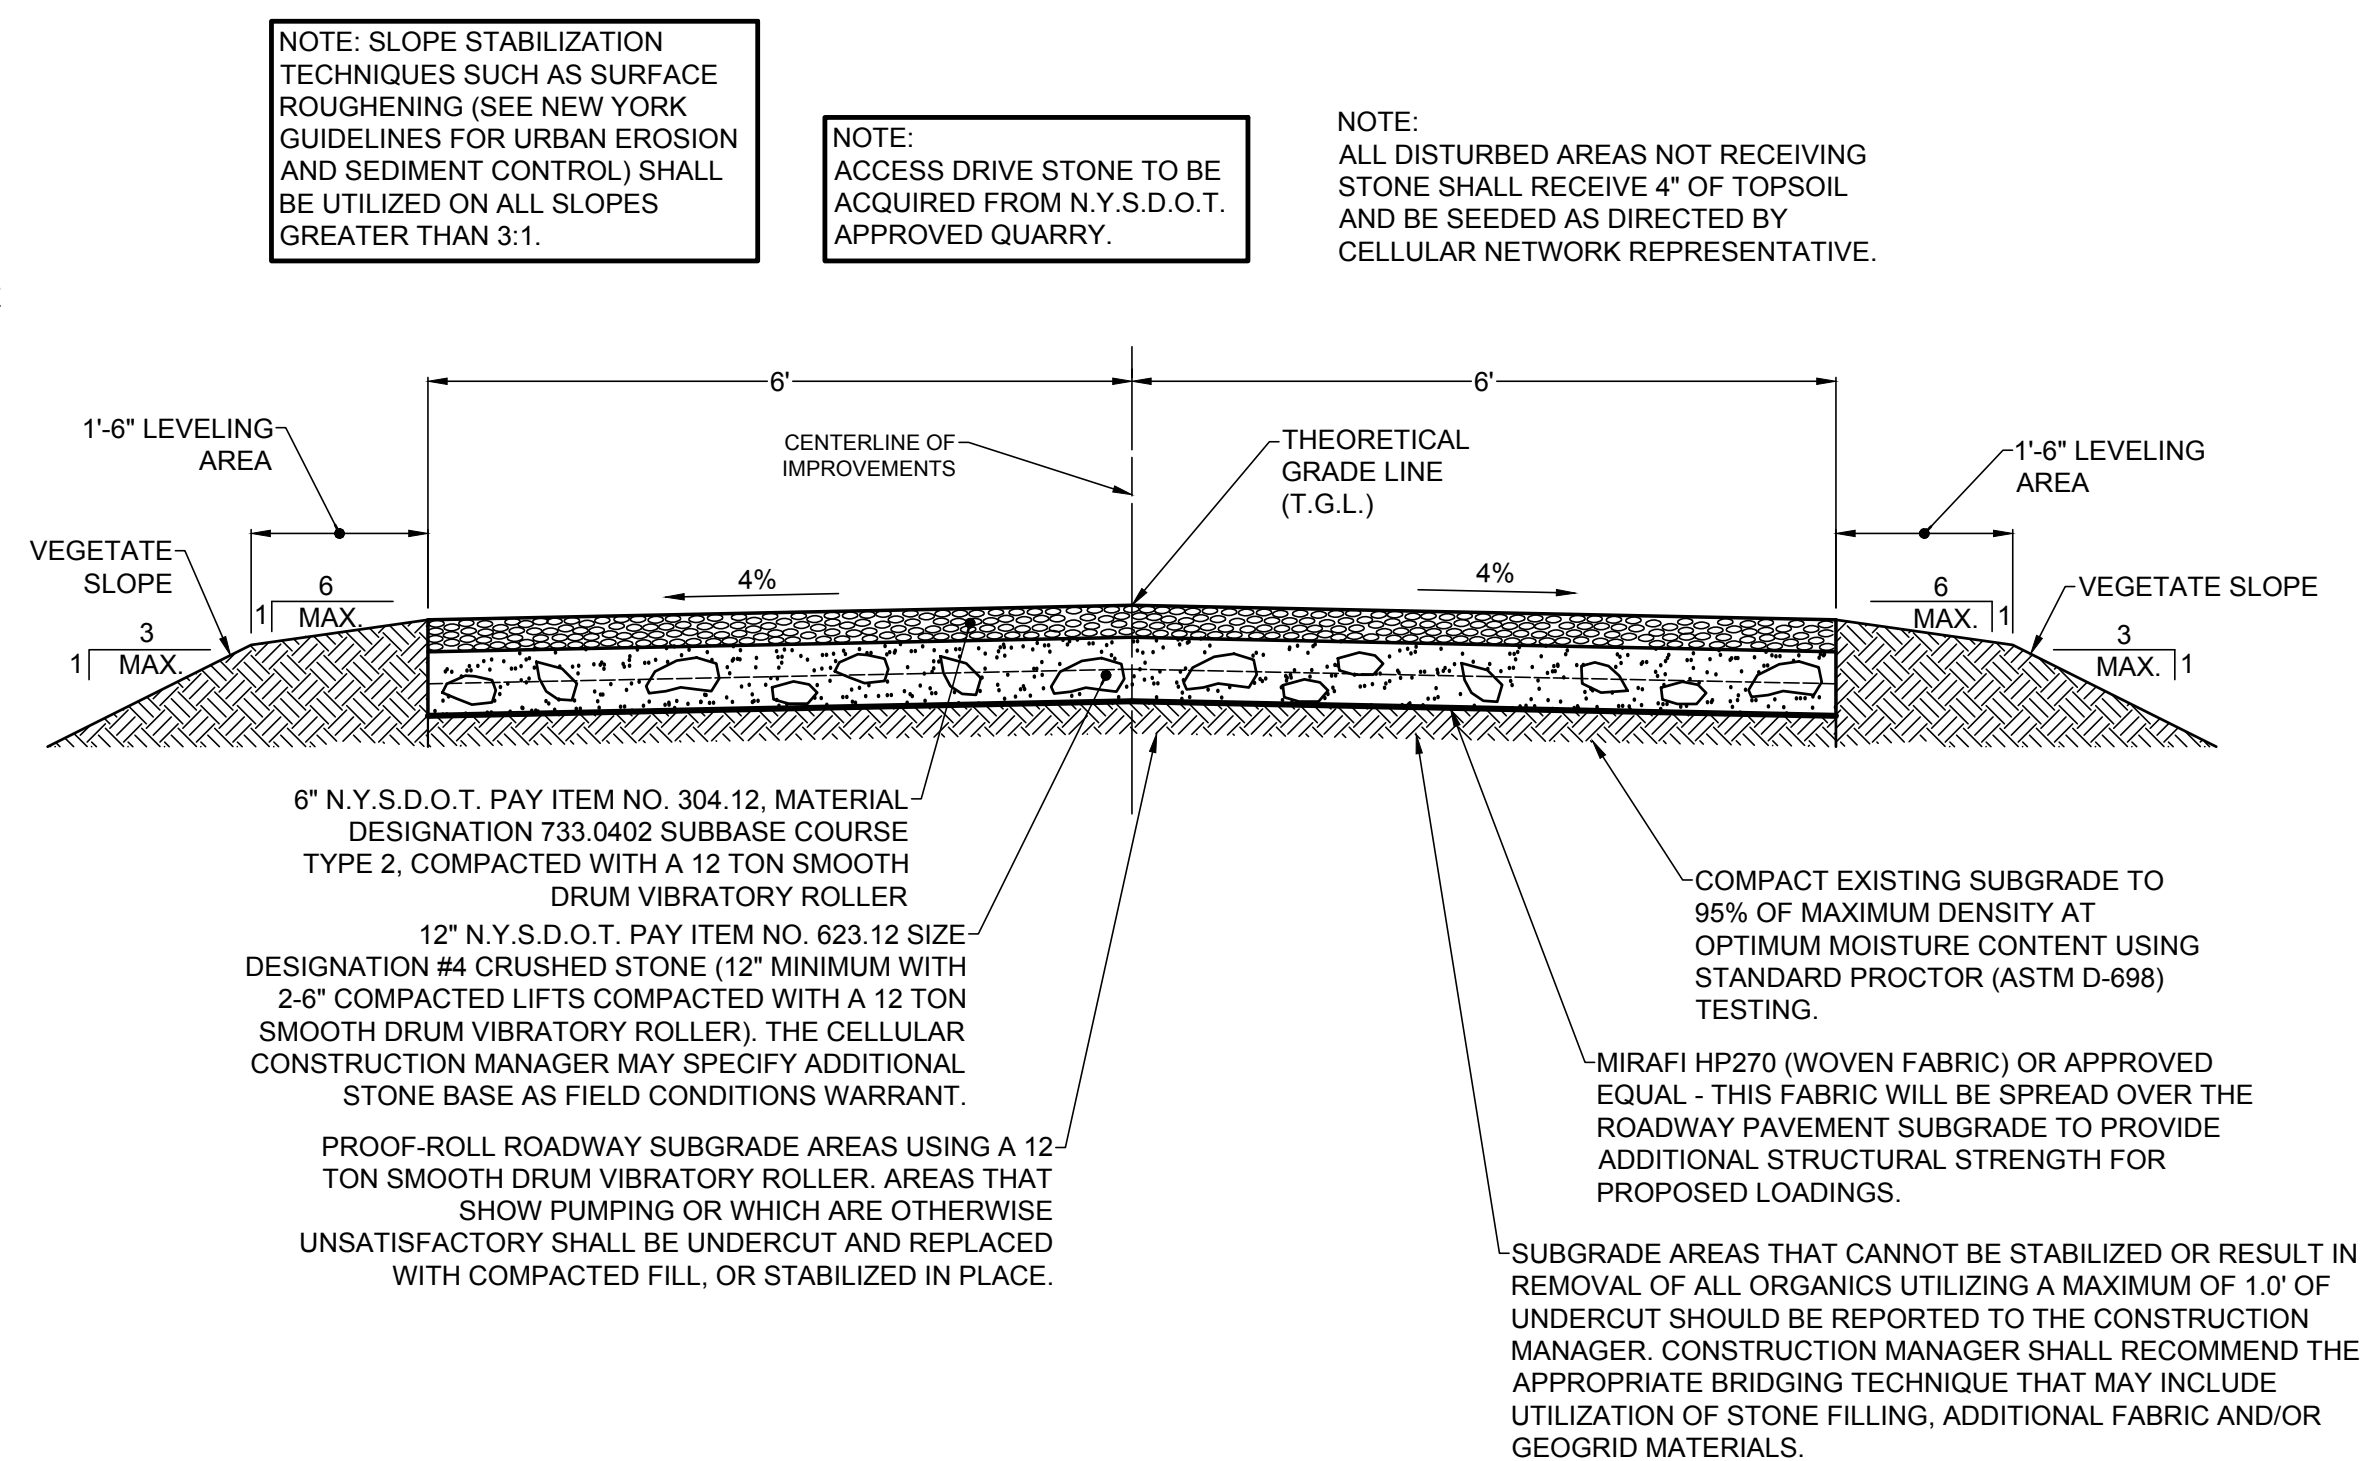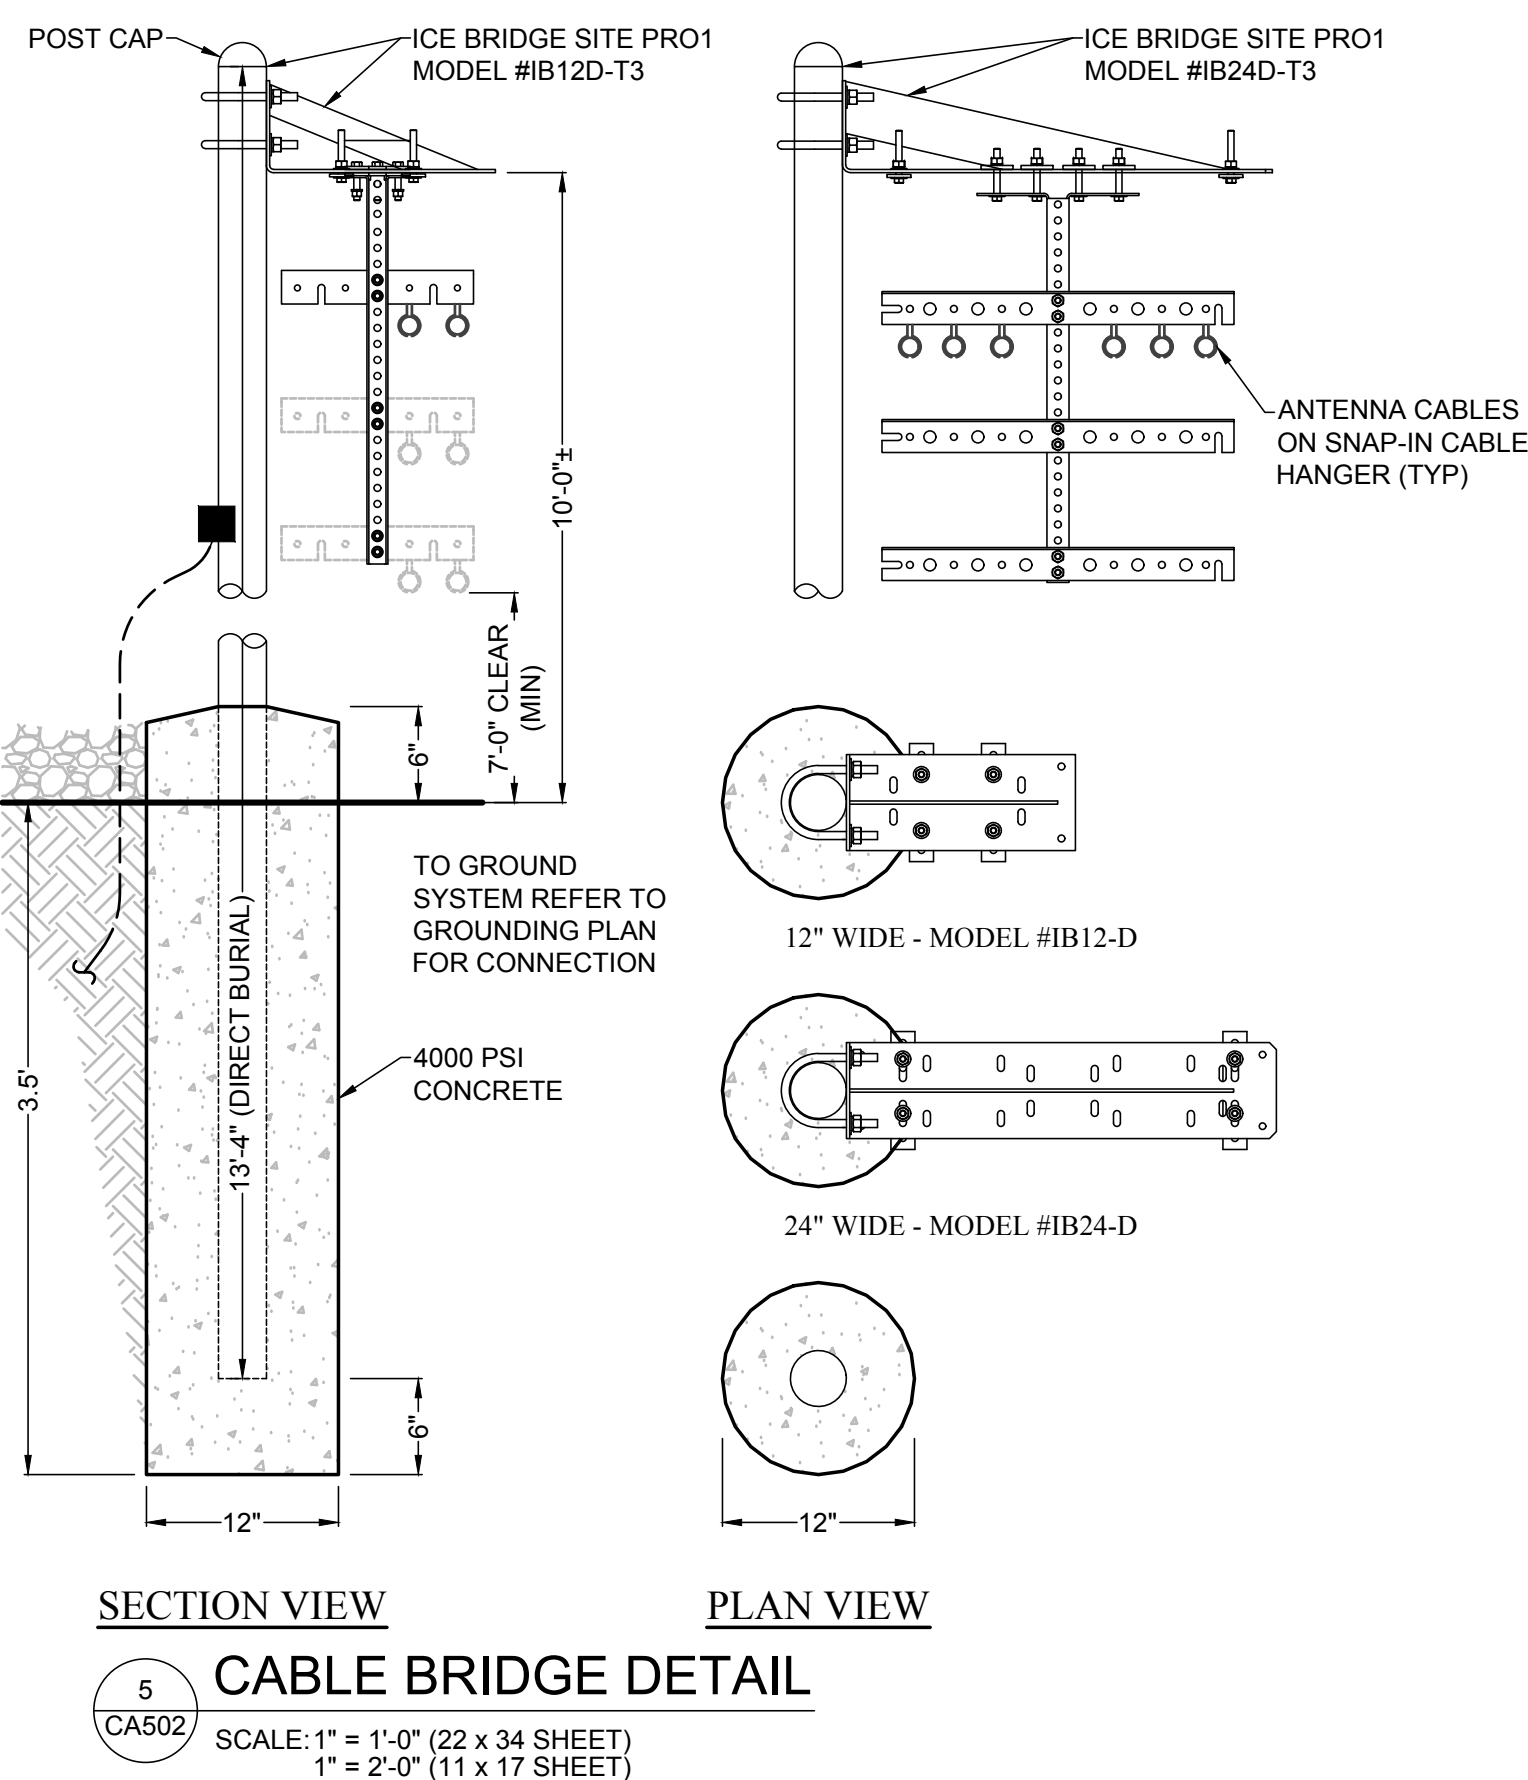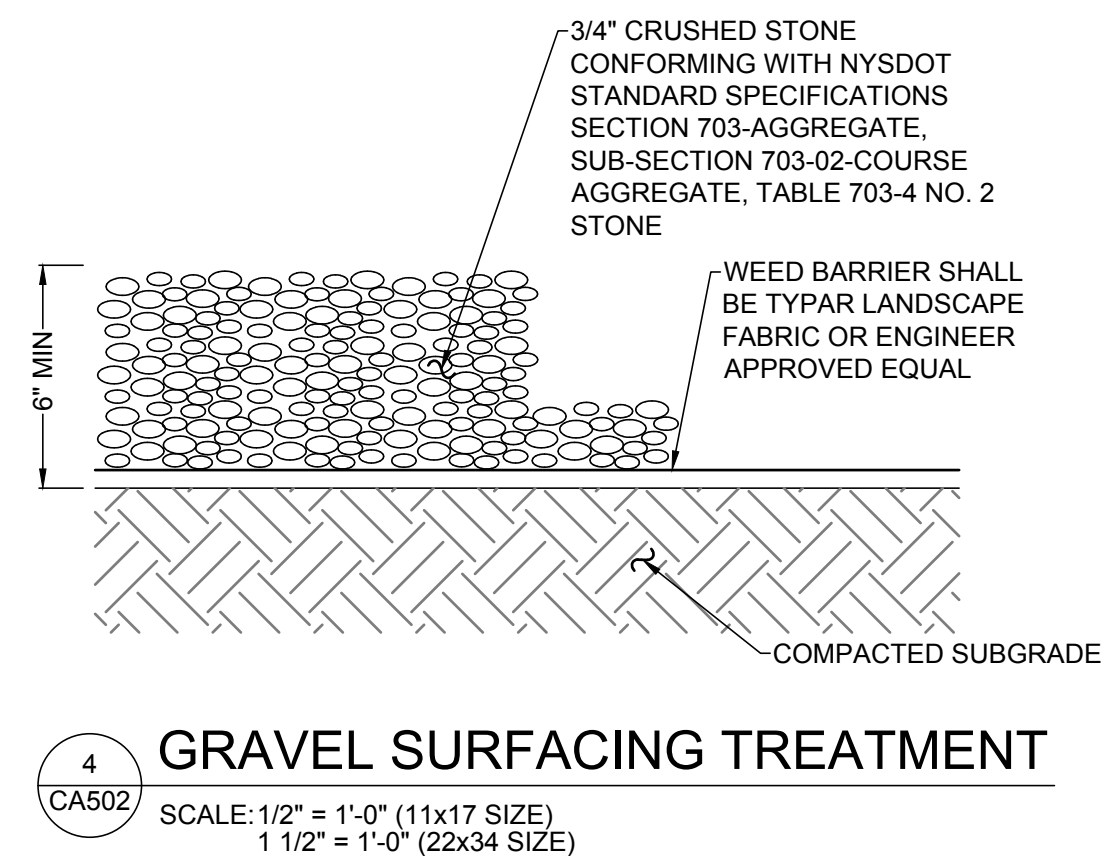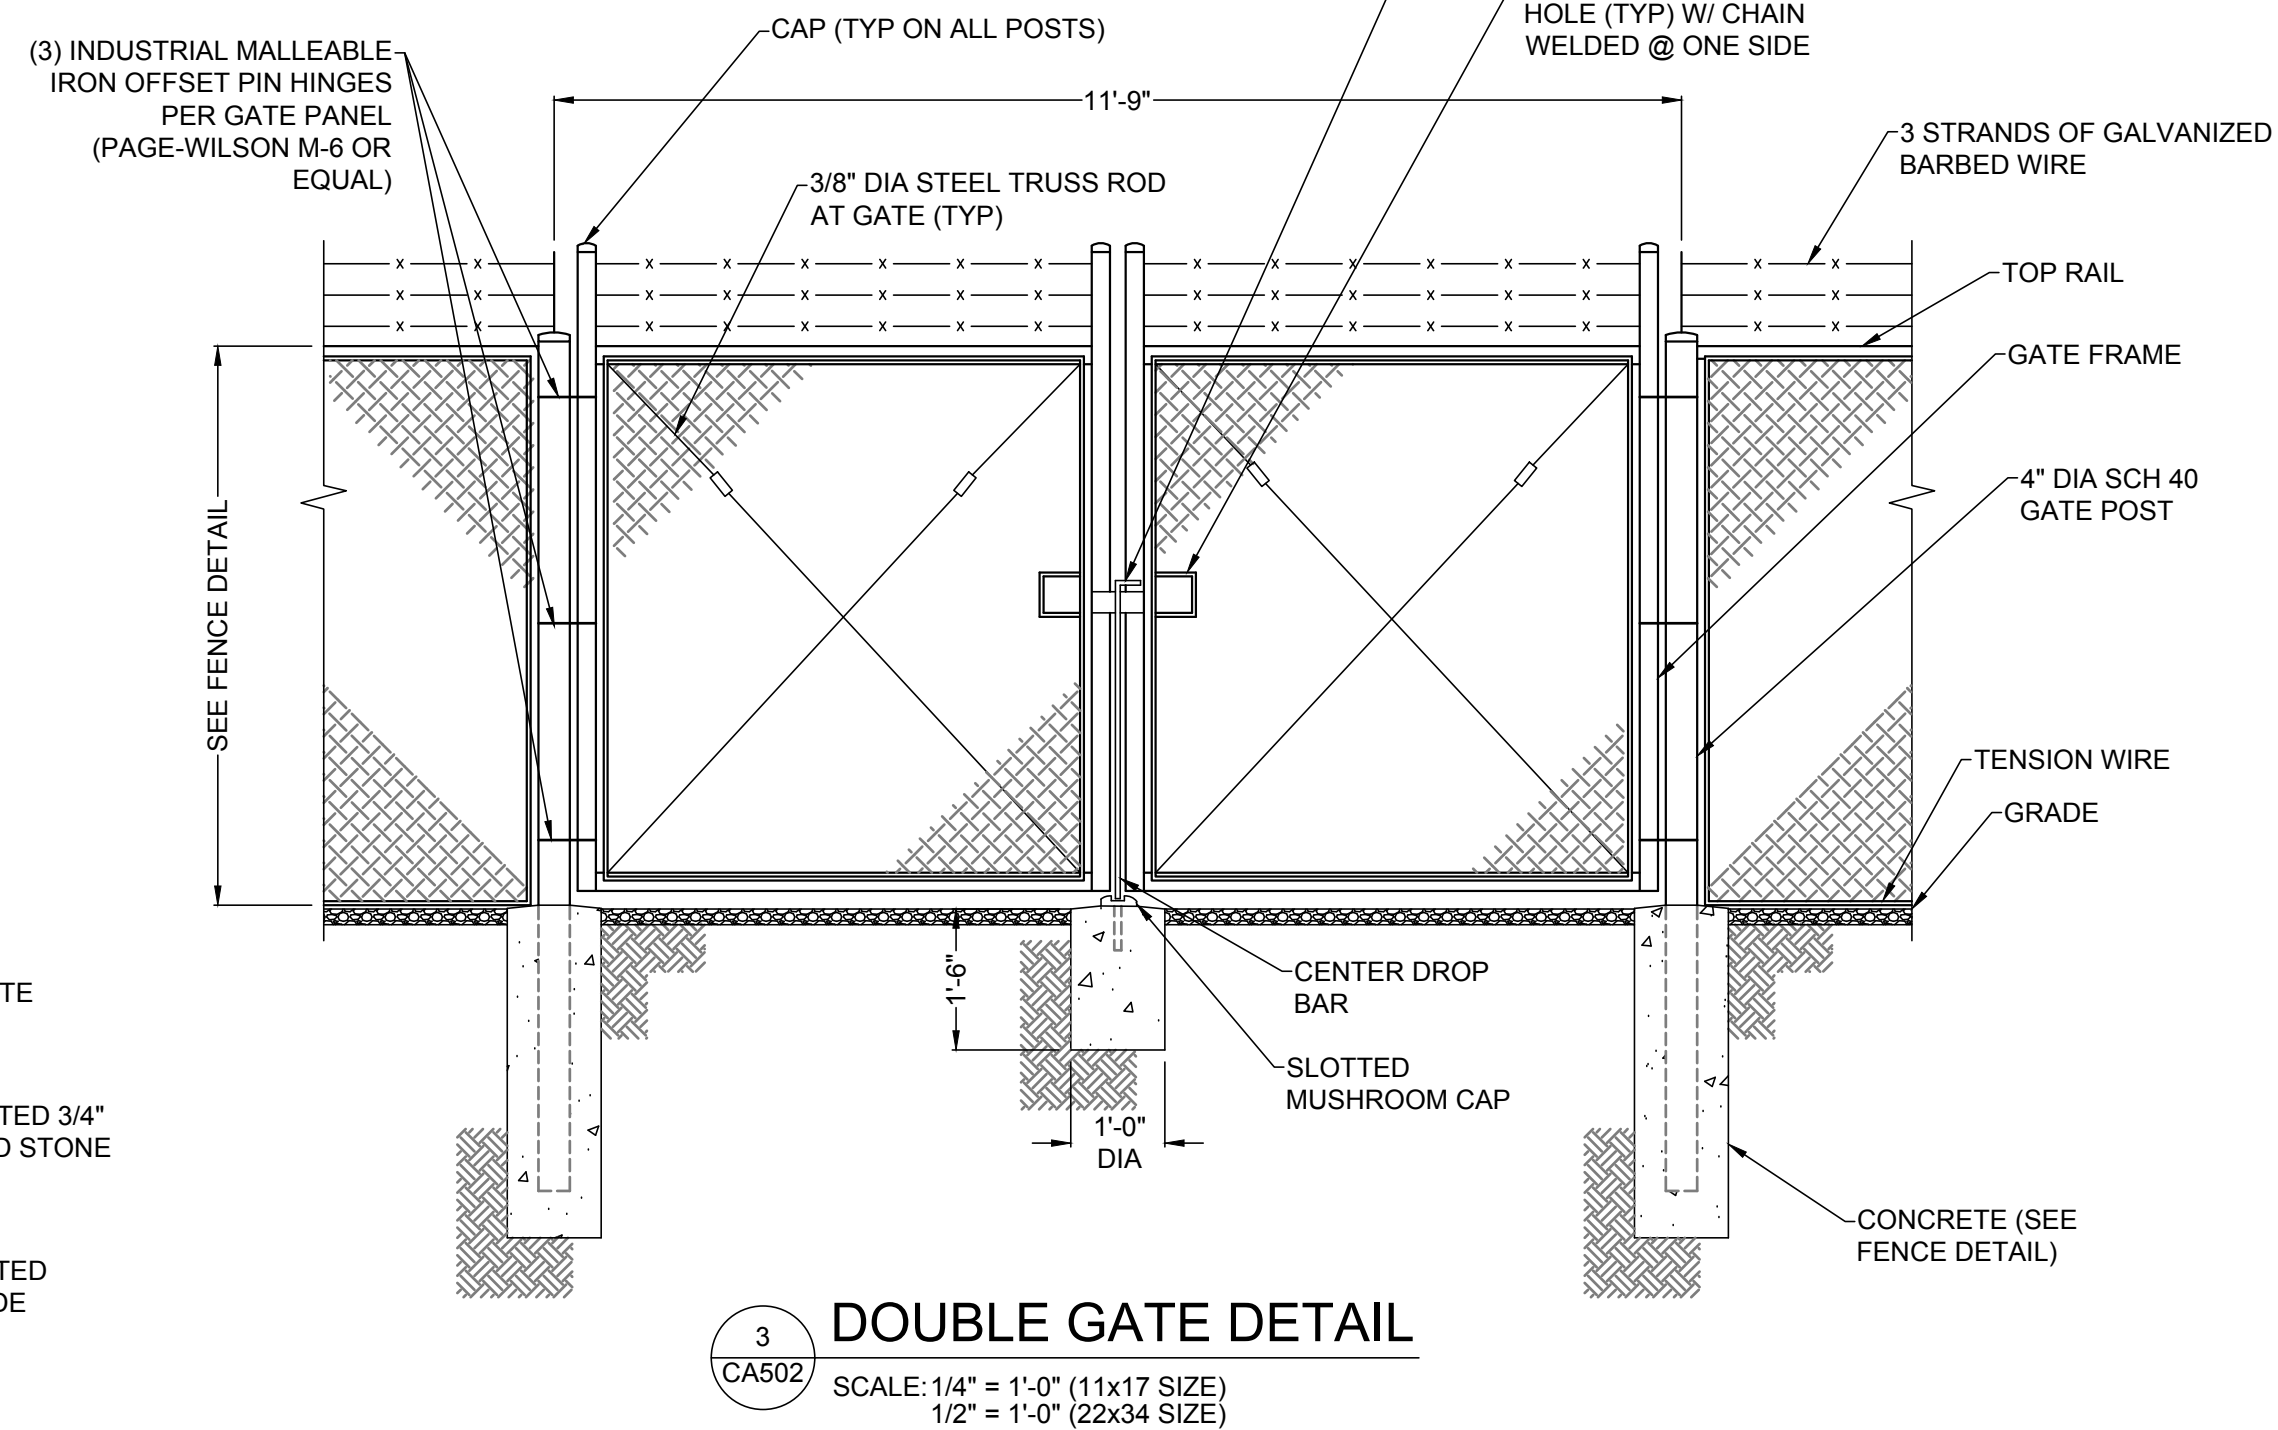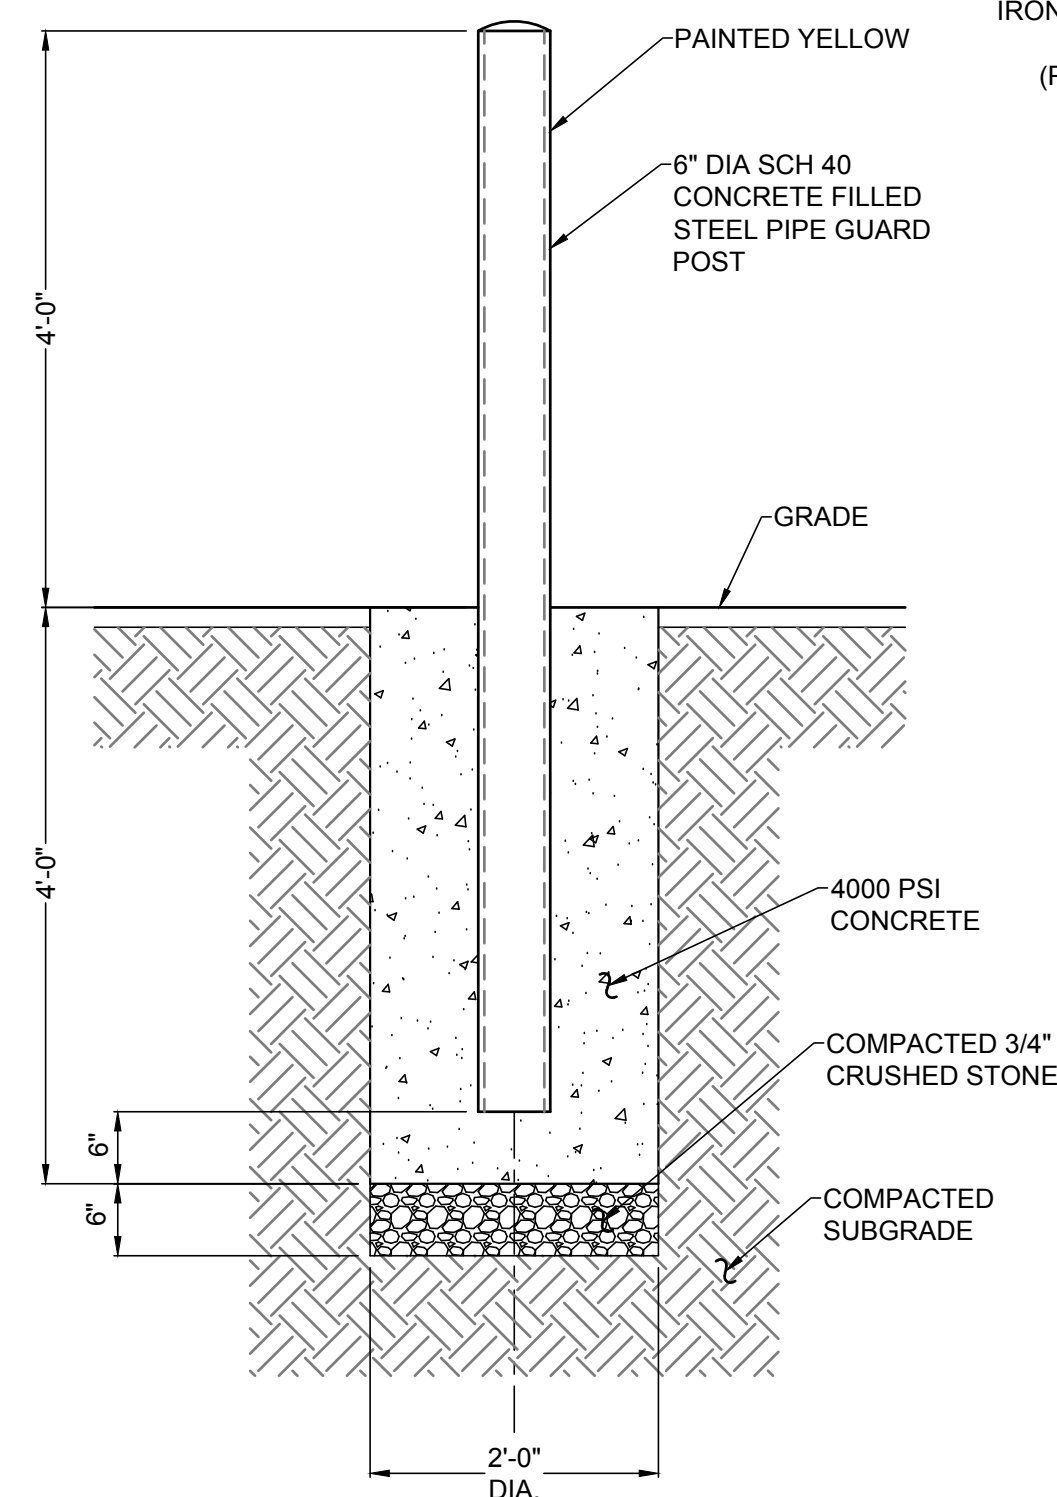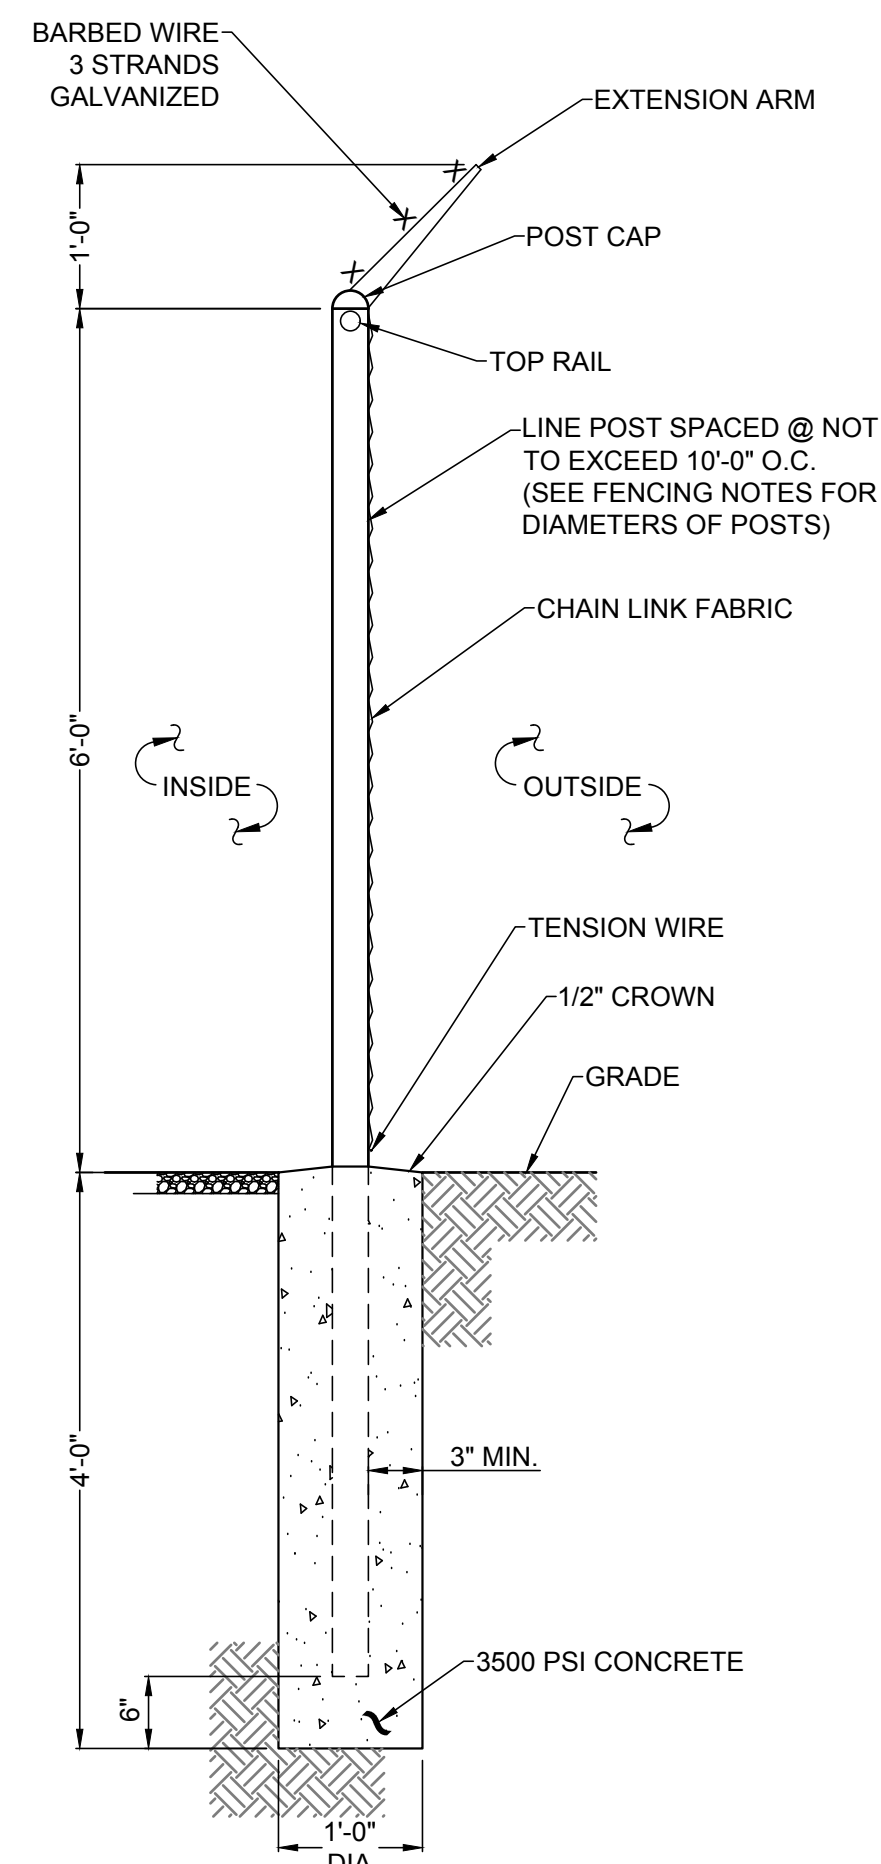

- CIVIL ENGINEERING
- LAND SURVEYING
- LANDSCAPE ARCHITECTURE

217 LAKE AVENUE  
ROCHESTER, NY 14608  
(585) 458-3020

[illegible]PROJECT  
MANAGER

D.A.W.

DRAWN BY

T.K.W.

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## SITE INFORMATION

ATTICA  
SITE #: NY 1008

VILLAGE OF ATTICA  
COUNTY OF WYOMING  
STATE OF NEW YORK

SHEET TITLE

## SITE DETAILS

C.E. JOB NUMBER


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SHEET NUMBER

CA502

SHEET 10 OF 11




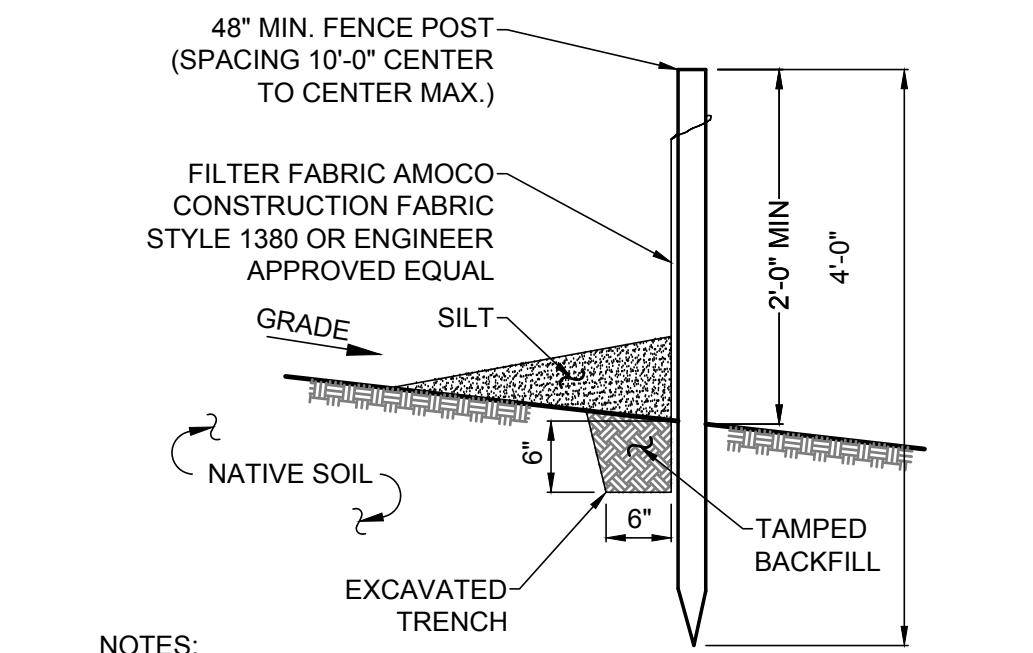

- NOTES:
- SILT FENCE SHALL BE MAINTAINED IN PLACE DURING CONSTRUCTION AND SOIL STABILIZATION PERIOD.
  - CONTRACTOR SHALL CONSTRUCT SILT FENCE IN ACCORDANCE WITH MANUFACTURER'S REQUIREMENTS.
  - EXCAVATE TRENCH 6" WIDE X 6" DEEP. BURY BOTTOM 12" OF FABRIC AND TAMP IN PLACE.
  - WHEN FENCE IS NO LONGER NEEDED, THE ACCUMULATED SILT, ALL THE POSTS AND FABRIC SHALL BE REMOVED AND TRENCH BACK FILLED WITH TOPSOIL AND SEEDED.

### 1 SILT FENCE DETAIL

CA503 SCALE:NTS

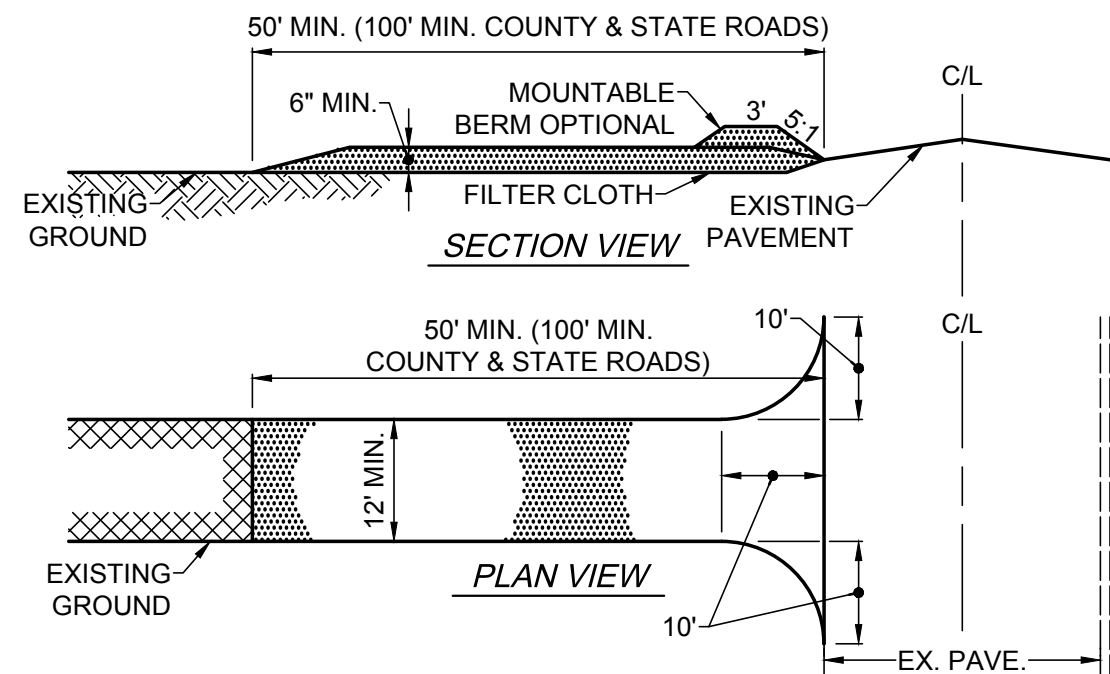


### 2 STABILIZED CONSTRUCTION ENTRANCE DETAIL

CA503 SCALE:SCALE: NTS

#### CONSTRUCTION SPECIFICATIONS AND NOTES


- STONE SIZE - USE 1.4" STONE, OR RECLAIMED OR RECYCLED CONCRETE EQUIVALENT.
- LENGTH - AS REQUIRED, (100 FT. MIN. FOR ACCESS TO COUNTY OR STATE ROADS) NOT LESS THAN 50 FT. (EXCEPT ON SINGLE RESIDENCE LOT WHERE A 30 FT. MINIMUM LENGTH SHALL APPLY.
- THICKNESS - NOT LESS THAN SIX (6) INCHES.
- WIDTH - TWELVE (12) FOOT MINIMUM, BUT NOT LESS THAN THE FULL WIDTH AT POINTS WHERE INGRESS OR EGRESS OCCURS. TWENTY FOUR (24) FOOT IF SINGLE ENTRANCE TO SITE.
- GEOTEXTILE - WILL BE PLACED OVER THE ENTIRE AREA PRIOR TO PLACING OF STONE.
- SURFACE WATER - ALL SURFACE WATER FLOWING AND/OR DIVERTED TOWARD CONSTRUCTION ENTRANCES SHALL BE PIPED BENEATH THE ENTRANCE. IF THE PIPING IS IMPRACTICAL, A MOUNTING BERM WITH 5:1 SLOPES WILL BE PERMITTED.
- MAINTENANCE - THE ENTRANCE SHALL BE MAINTAINED IN A CONDITION WHICH WILL PREVENT TRACKING OR FLOWING OF SEDIMENT ONTO PUBLIC RIGHTS-OF-WAY, ALL SEDIMENT SPILLED, DROPPED, WASHED OR TRACKED ONTO PUBLIC RIGHTS-OF-WAY MUST BE REMOVED IMMEDIATELY.
- WASHING - WHEN WASHING IS REQUIRED, IT SHALL BE DONE ON AN AREA STABILIZED WITH STONE AND WHICH DRAINS INTO AN APPROVED SEDIMENT TRAPPING DEVICE.
- PERIODIC INSPECTION & NEEDED MAINTENANCE SHALL BE PROVIDED AFTER EACH RAIN.

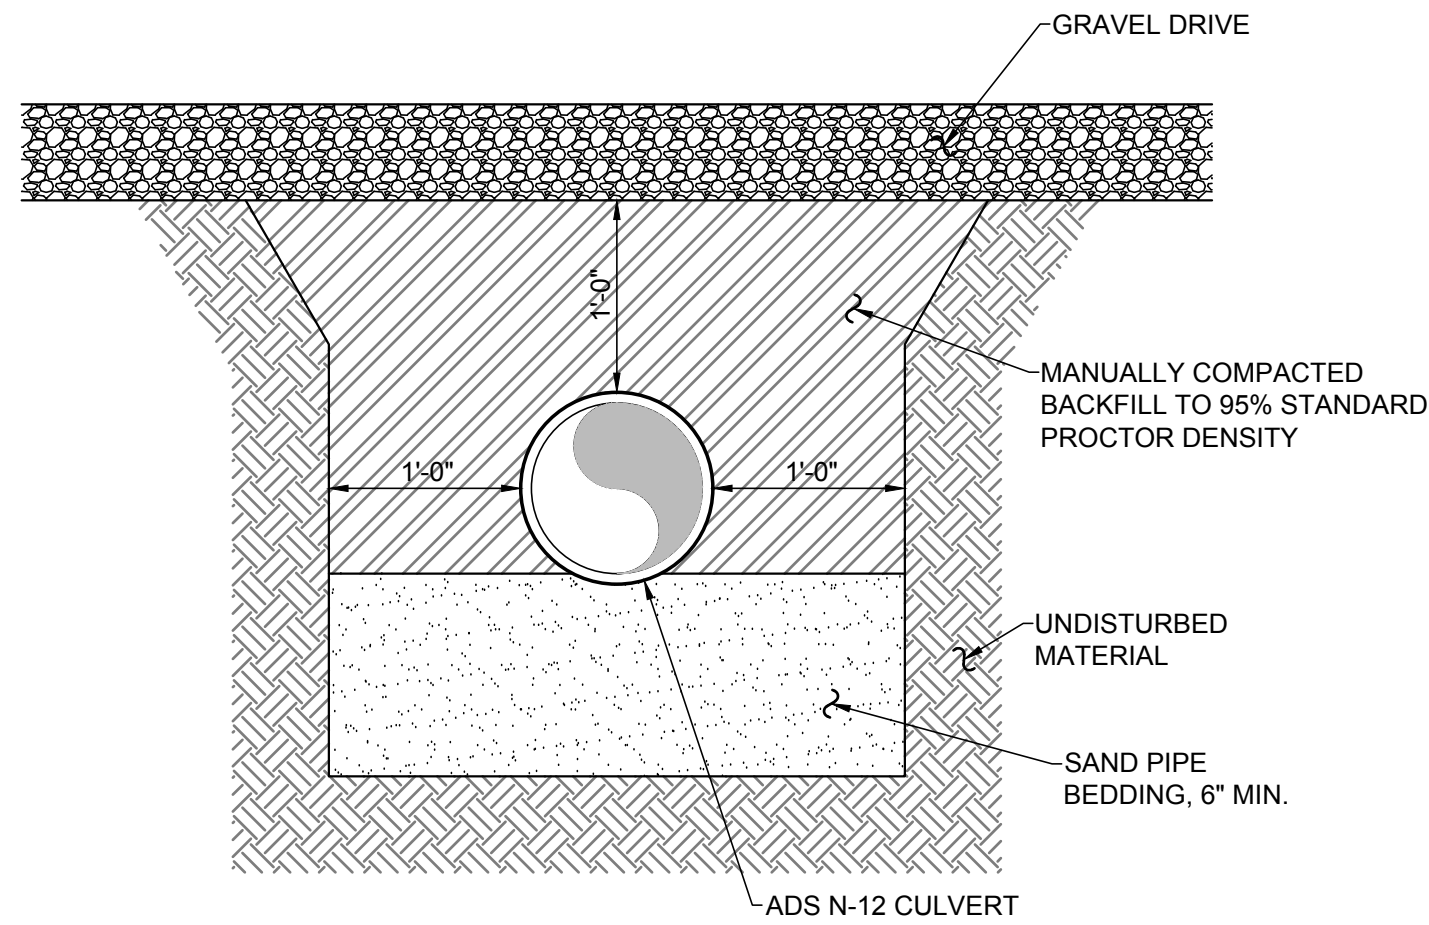


- NOTES:
- OVER-EXCAVATE FOR BELLS.
  - ADDITIONAL BEDDING MAY BE USED AS ORDERED BY ENGINEER.
  - ALL EXCAVATION AND TRENCHING SHALL MEET OSHA REQUIREMENTS.

### 3 CULVERT TRENCH DETAIL

CA503 SCALE: 1/2" = 1'-0" (11x17 SIZE)  
1" = 1'-0" (22x34 SIZE)

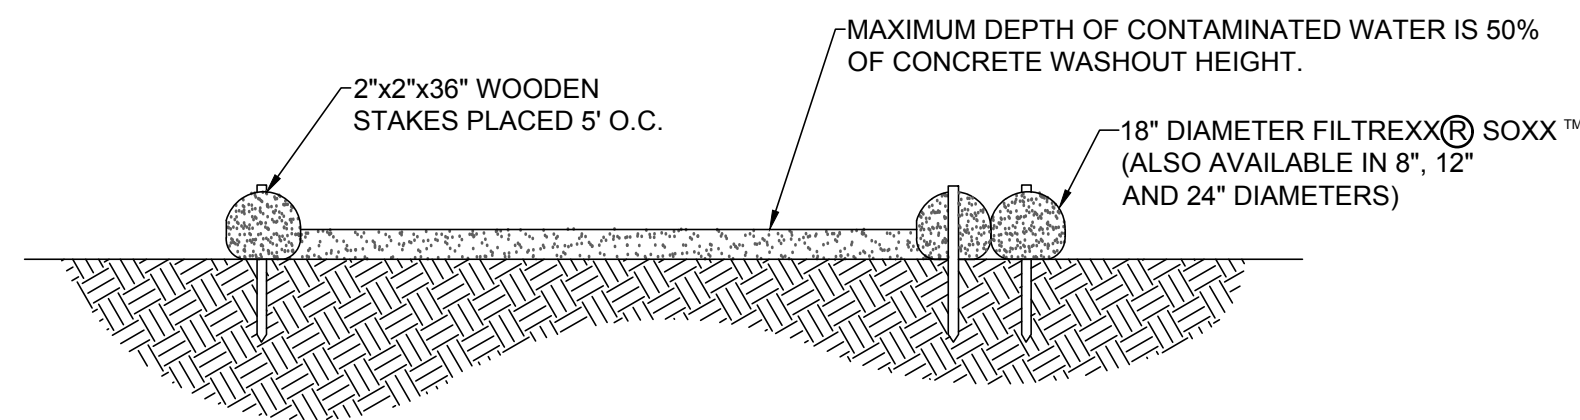

#### SECTION VIEW

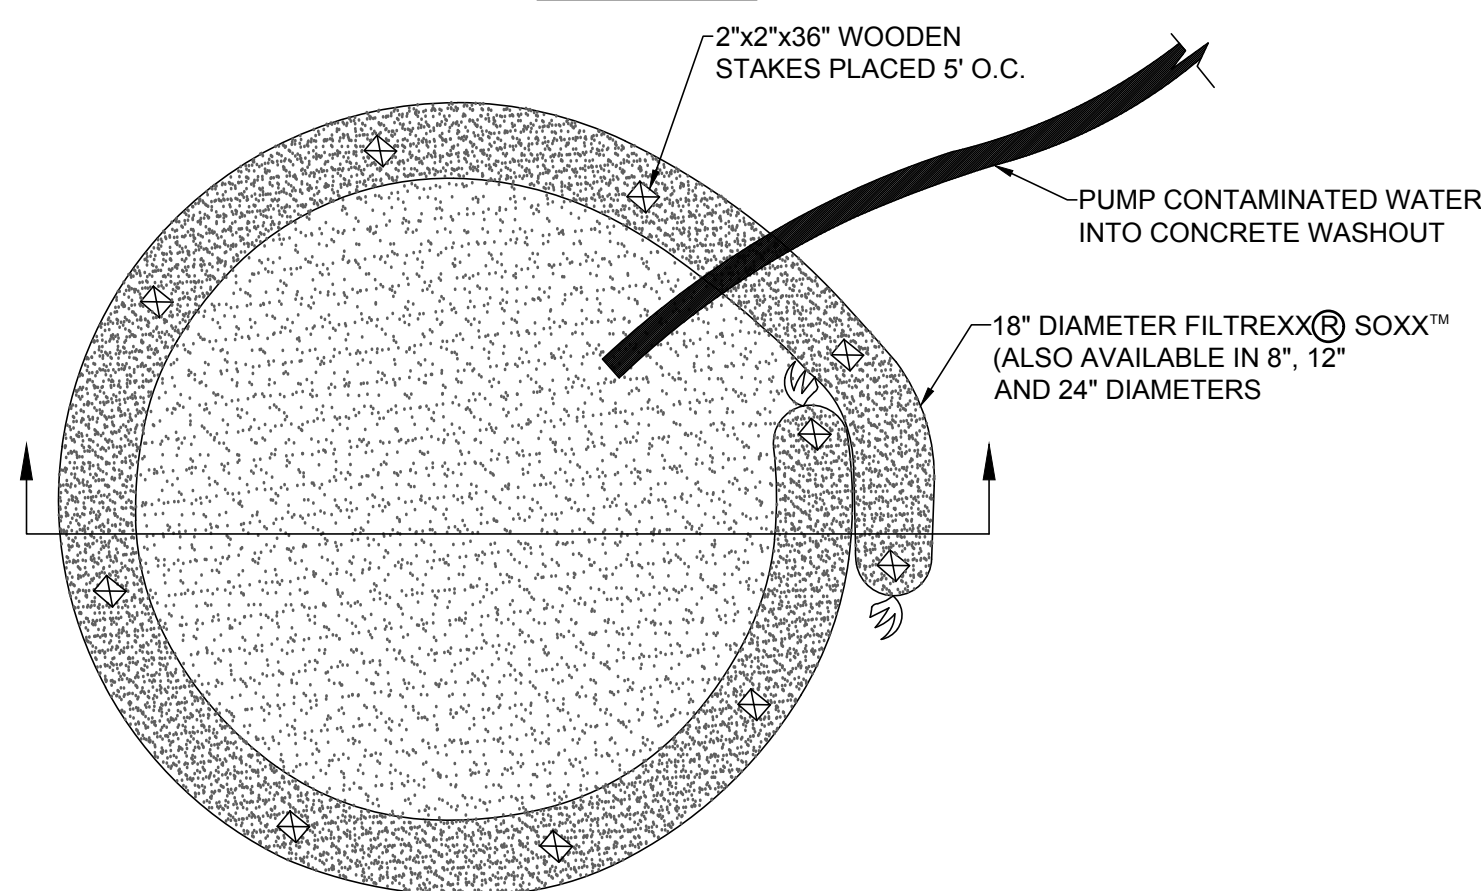


#### PLAN VIEW

NOTES:  
FOR ANY PROJECT ON WHICH CONCRETE WILL BE POURED OR OTHERWISE FORMED ON SITE, A SUITABLE WASHOUT FACILITY MUST BE PROVIDED FOR THE CLEANING OF CHUTES, MIXERS, AND HOPPERS OF THE DELIVERY VEHICLES UNLESS SUCH A FACILITY WILL BE USED AT THE SOURCE OF THE CONCRETE.

- UNDER NO CIRCUMSTANCES MAY WASH WATER FROM THESE VEHICLES BE ALLOWED TO ENTER ANY SURFACE WATERS.
- CONCRETE WASHOUT SHALL BE UNDERLAYED WITH 4 MIL. THICK PLASTIC BUFFER.
- MAKE SURE THAT PROPER SIGNAGE IS PROVIDED TO DRIVERS SO THAT THEY ARE AWARE OF THE PRESENCE OF WASHOUT FACILITIES.
- WASHOUT FACILITIES SHOULD NOT BE PLACED WITHIN 50 FEET OF STORM DRAINS, OPEN DITCHES OR SURFACE WATERS.
- INSTALL ON FLAT GRADE NOT TO EXCEED 2%.
- CONCRETE WASHOUT MAY BE STACKED IN A PYRAMIDAL CONFIGURATION FOR ADDED HEIGHT AND STABILITY.
- CONCRETE WASHOUT MAY BE DIRECT SEEDED AT THE TIME OF INSTALLATION.
- THEY SHOULD BE IN A CONVENIENT LOCATION FOR THE TRUCKS, PREFERABLY NEAR THE PLACE WHERE THE CONCRETE IS BEING POURED.
- CONCRETE WASHOUT NOT TO BE LESS THAN 6' IN DIAMETER.

### 4 CONCRETE WASHOUT DETAIL

CA503 SCALE: NTS

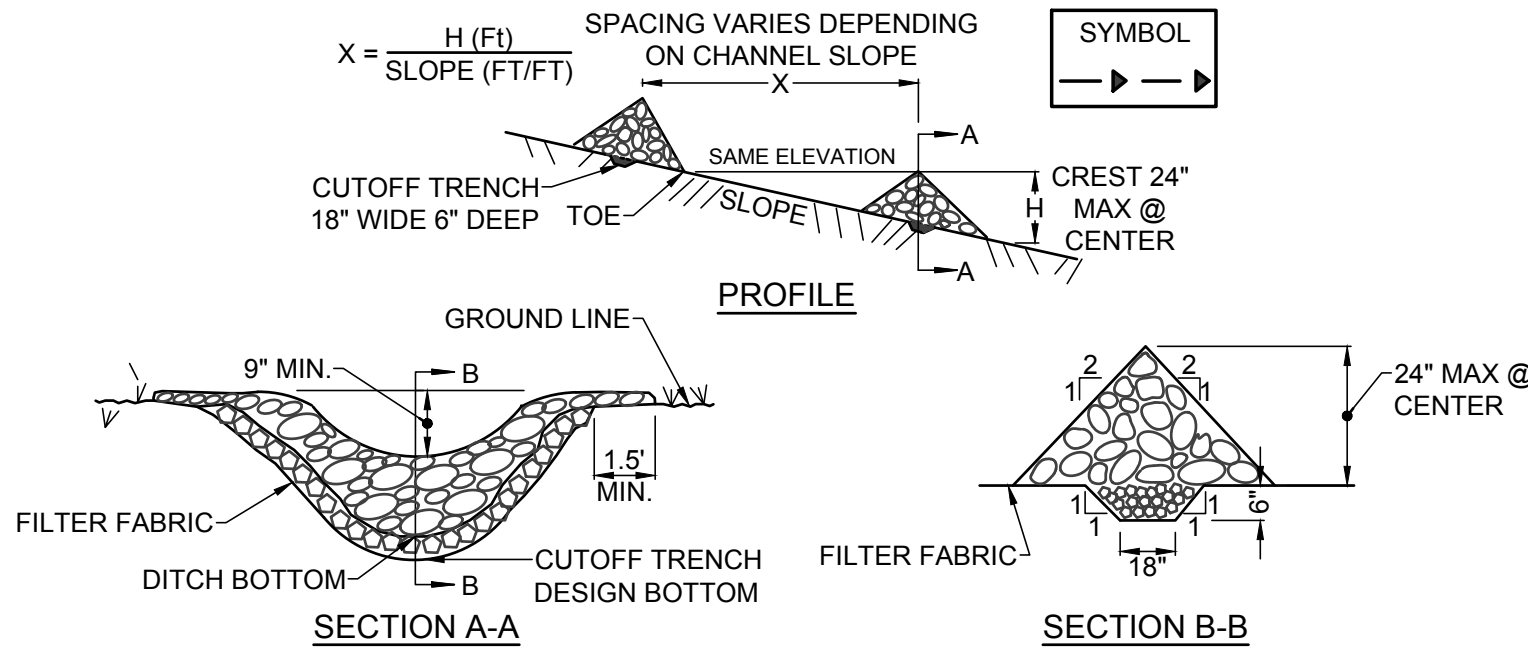

#### SECTION A-A


#### SECTION B-B

#### CONSTRUCTION SPECIFICATIONS

- STONE WILL BE PLACED ON A FILTER FABRIC FOUNDATION TO THE LINES, GRADES AND LOCATIONS SHOWN IN THE PLAN.
- SET SPACING OF CHECK DAMS TO ASSUME THAT THE ELEVATIONS OF THE CREST OF THE DOWNSTREAM DAM IS AT THE SAME ELEVATION OF THE TOE OF THE UPSTREAM DAM.
- EXTEND THE STONE A MINIMUM OF 1.5 FEET BEYOND THE DITCH BANKS TO PREVENT CUTTING AROUND THE DAM.
- PROTECT THE CHANNEL DOWNSTREAM OF THE LOWEST CHECK DAM FROM SCOUR AND EROSION WITH STONE OR LINER AS APPROPRIATE.
- ENSURE THAT CHANNEL APPURTENANCES SUCH AS CULVERT ENTRANCES BELOW CHECK DAMS ARE NOT SUBJECT TO DAMAGE OR BLOCKAGE FROM DISPLACED STONE.
- MAXIMUM DRAINAGE AREA 2 ACRES.

### 5 CHECK DAM DETAIL

CA503 SCALE:NTS

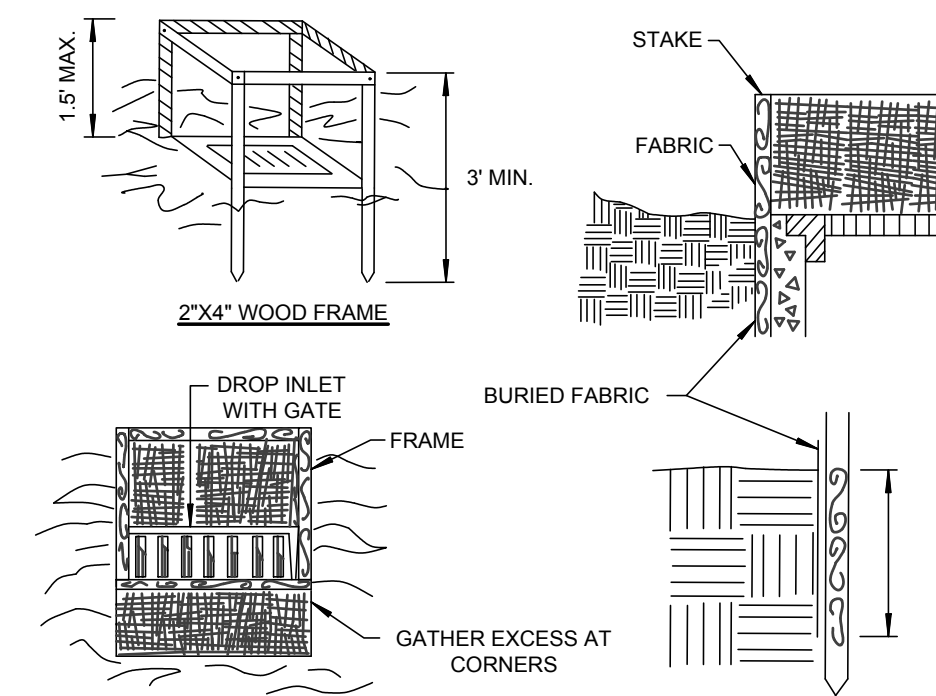

#### CONSTRUCTION SPECIFICATIONS

- FILTER FABRIC SHALL HAVE AN EOS OF 40-85. BURLAP MAY BE USED FOR SHORT TERM APPLICATIONS.
- CUT FABRIC FROM A CONTINUOUS ROLL TO ELIMINATE JOINTS. IF JOINTS ARE NEEDED THEY WILL BE OVERLAPPED TO THE NEXT STAKE.
- STAKE MATERIALS WILL BE STANDARD 2" x 4" WOOD OR EQUIVALENT. METAL WITH A MINIMUM LENGTH OF 3 FEET.
- SPACE STAKES EVENLY AROUND INLET 3 FEET APART AND DRIVE A MINIMUM 18 INCHES DEEP. SPANS GREATER THAN 3 FEET MAY BE BRIDGED WITH THE USE OF WIRE MESH BEHIND THE FILTER FABRIC FOR SUPPORT.
- FABRIC SHALL BE EMBEDDED 1 FOOT MINIMUM BELOW GROUND AND BACKFILLED. IT SHALL BE SECURELY FASTENED TO THE STAKES AND FRAME.
- A 2" x 4" WOOD FRAME SHALL BE COMPLETED AROUND THE CREST OF THE FABRIC FOR OVER FLOW STABILITY.

MAXIMUN DRAINAGE AREA 1 ACRE

### 6 INLET PROTECTION DETAIL

CA503 SCALE:NTS




1275 JOHN STREET, SUITE #100  
WEST HENRIETTA, NEW YORK 14586



- CIVIL ENGINEERING
- LAND SURVEYING
- LANDSCAPE ARCHITECTURE

217 LAKE AVENUE  
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NO.	DATE	COMMENTS
0	10/26/2020	ISSUED PRELIMINARY FOR REVIEW
1	10/30/2020	REVISED PER COMMENTS; ISSUED FINAL

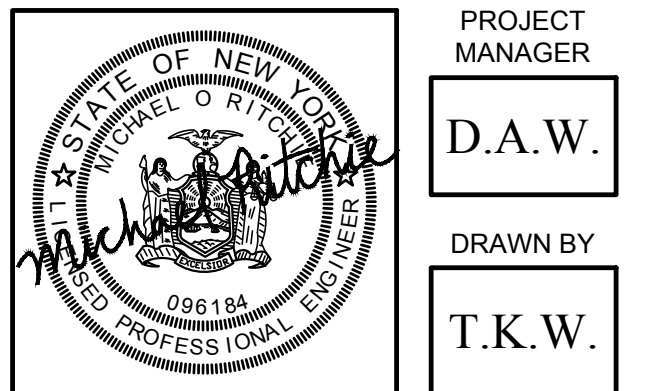


PROJECT  
MANAGER

D.A.W.

DRAWN BY

T.K.W.

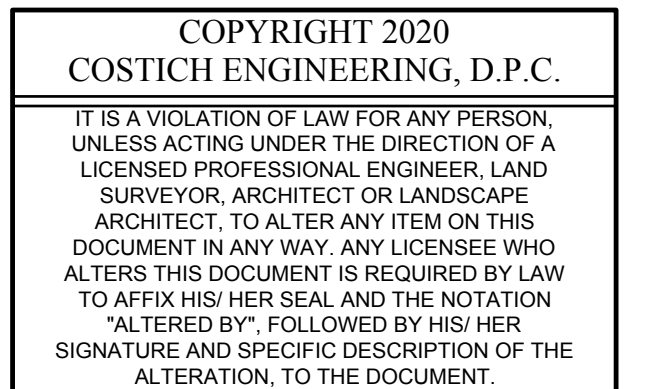

#### SITE INFORMATION

ATTICA  
SITE #: NY 1008

VILLAGE OF ATTICA  
COUNTY OF WYOMING  
STATE OF NEW YORK

#### SHEET TITLE

EROSION CONTROL  
DETAILS

C.E. JOB NUMBER SHEET NUMBER

7706.01 CA503

SHEET 11 OF 11